

M5 Junction 10 Improvements Scheme

Biodiversity Sites and Features Plan - Part 1 TR010063 - APP 2.11

Regulation 5 (2) (I)

Planning Act 2008

Infrastructure Planning (Applications: Prescribed Forms and Procedure) Regulations 2009

Volume 2

December 2023

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**Infrastructure Planning
Planning Act 2008**

**The Infrastructure Planning
(Applications: Prescribed Forms and
Procedure) Regulations 2009**

**M5 Junction 10 Improvements Scheme
Development Consent Order 202[x]**

Biodiversity Sites and Features Plan - Part 1

Regulation Number:	Regulation 5 (2) (l)
Planning Inspectorate Scheme Reference	TR010063
Application Document Reference	TR010063 – APP 2.11
Author:	M5 Junction 10 Improvement Scheme Project Team

Version	Date	Status of Version
Rev 0	December 2023	DCO Application

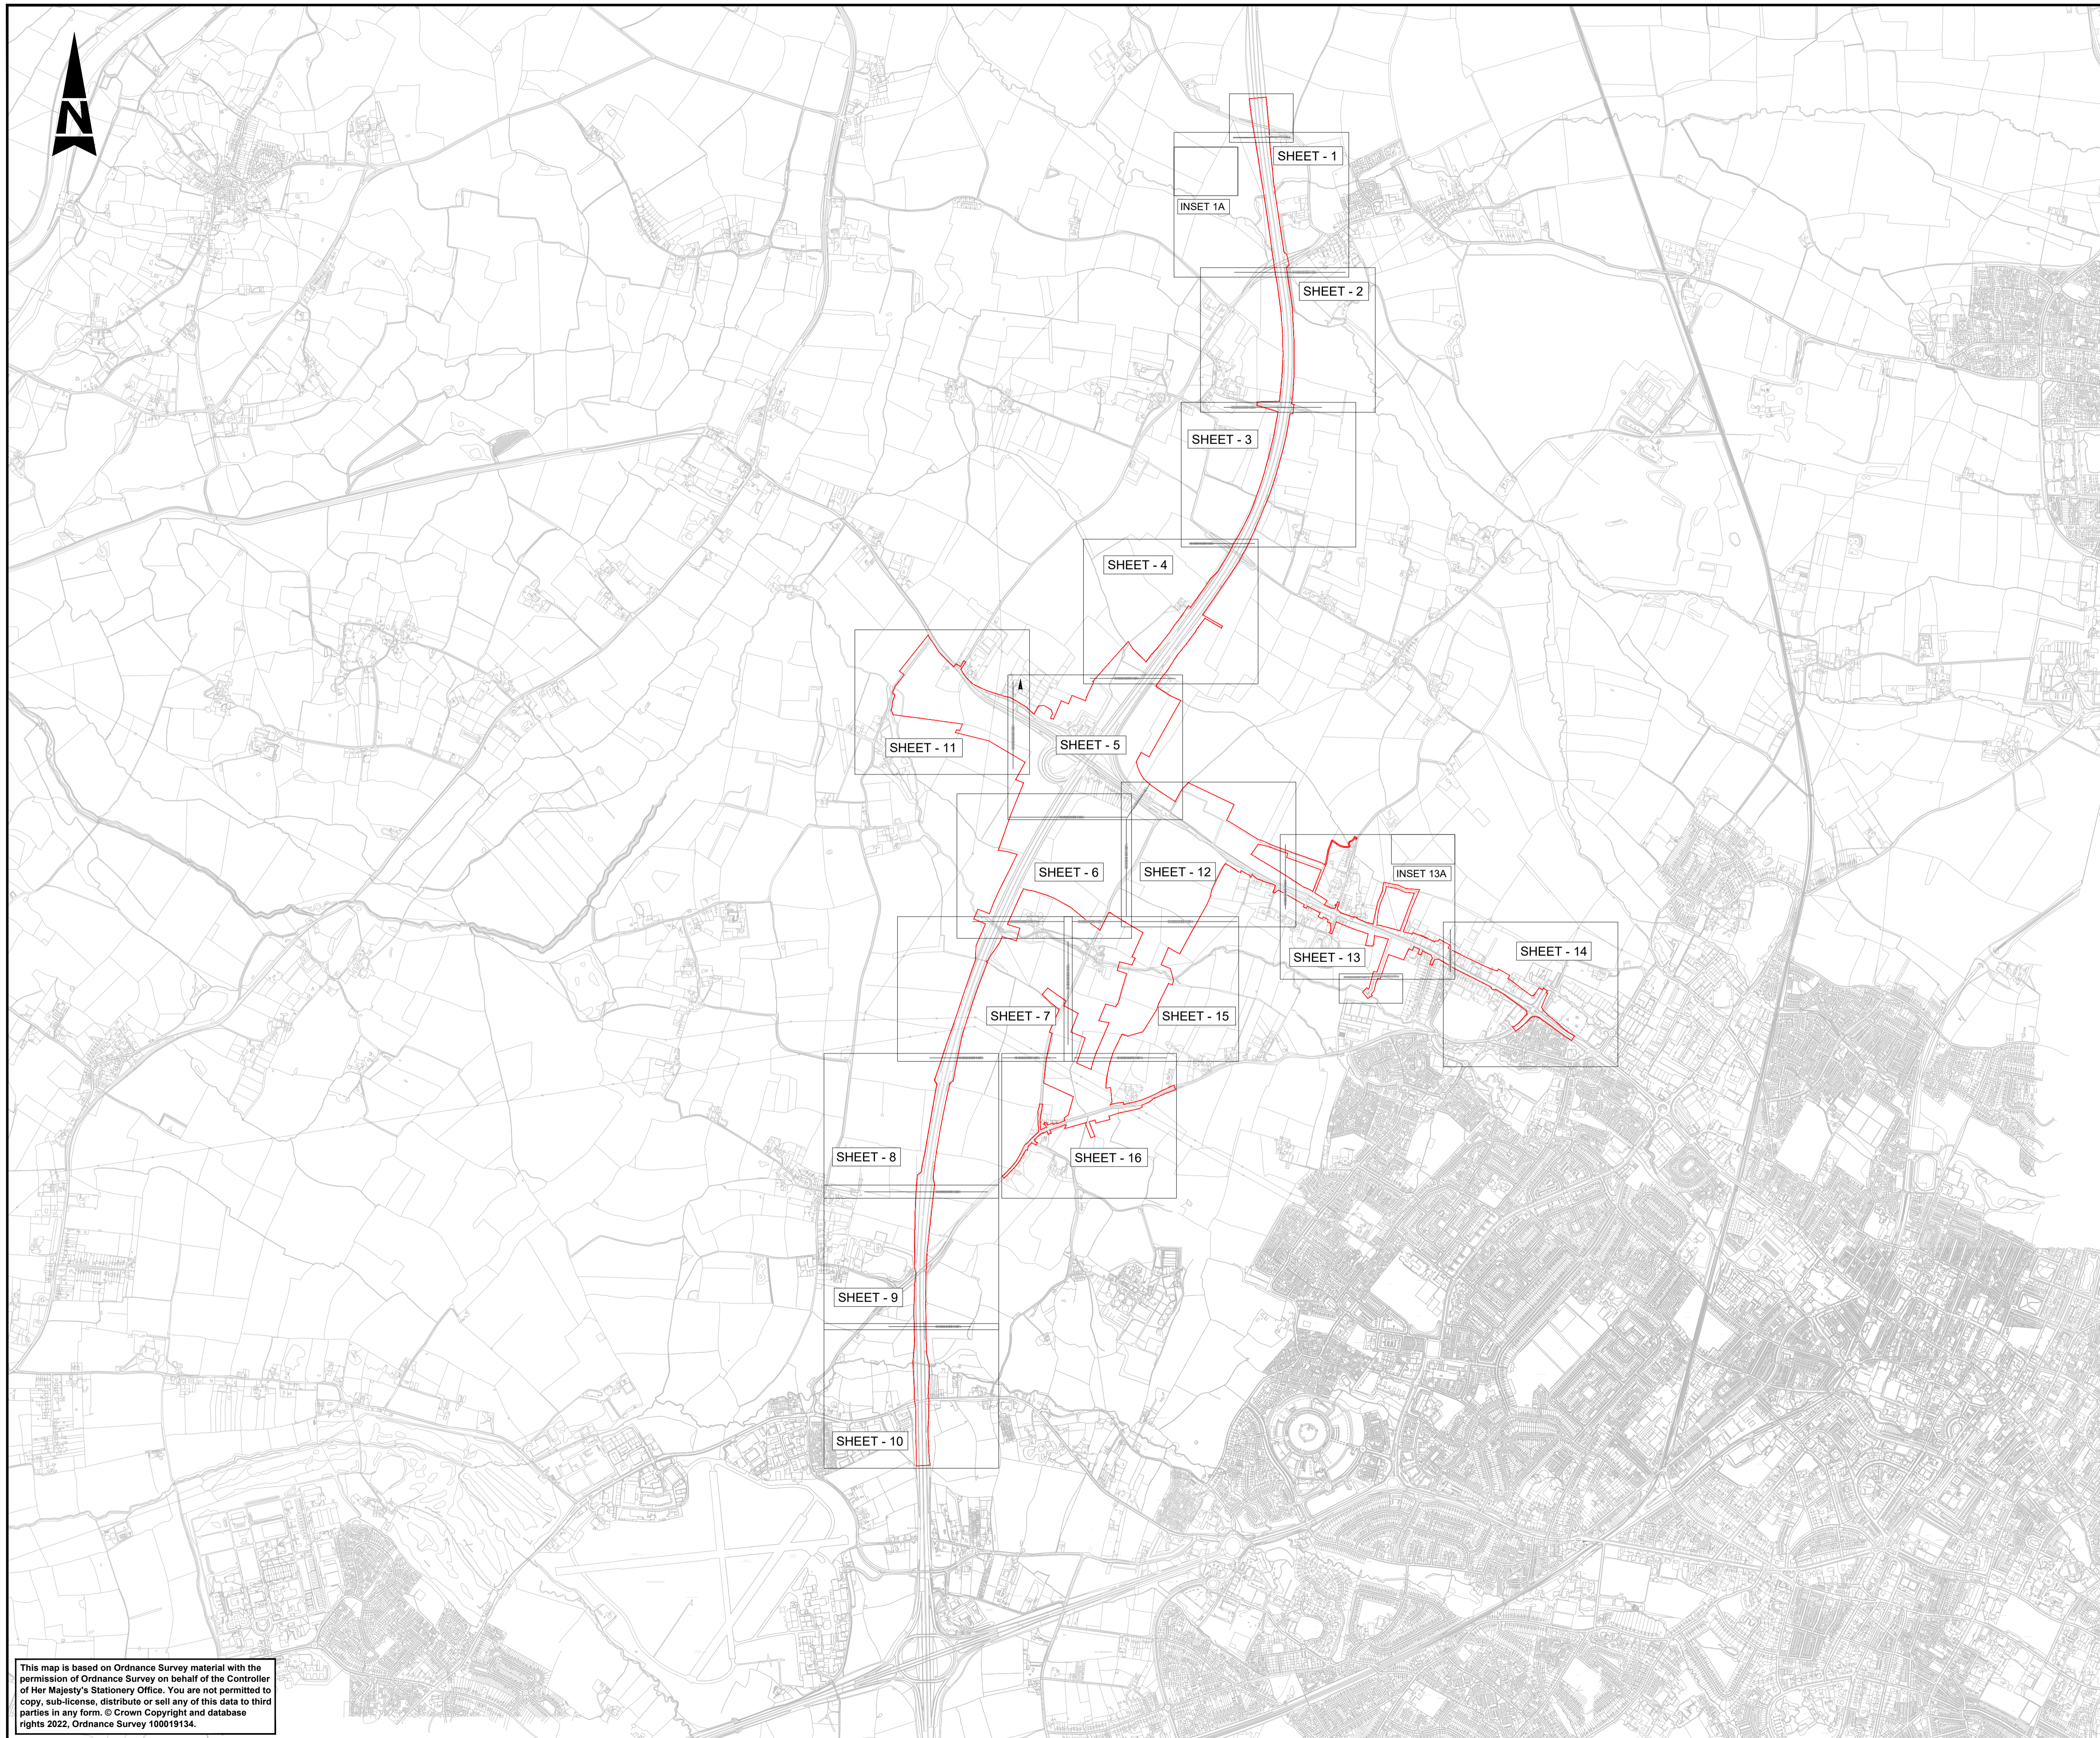
1. Schedule of Plans included in the application

1.1. List of drawings in Part 1

Document Title	Document Number	Revision
Biodiversity Sites and Features Plan – Key Plan	TR010063 – APP 2.11	C01
Biodiversity Sites and Features Plan – Site Plan	TR010063 – APP 2.11	C01
Biodiversity Sites and Features Plan – Sheet 1 of 16	TR010063 – APP 2.11	C01
Biodiversity Sites and Features Plan – Sheet 2 of 16	TR010063 – APP 2.11	C01
Biodiversity Sites and Features Plan – Sheet 3 of 16	TR010063 – APP 2.11	C01
Biodiversity Sites and Features Plan – Sheet 4 of 16	TR010063 – APP 2.11	C01
Biodiversity Sites and Features Plan – Sheet 5 of 16	TR010063 – APP 2.11	C01
Biodiversity Sites and Features Plan – Sheet 6 of 16	TR010063 – APP 2.11	C01
Biodiversity Sites and Features Plan – Sheet 7 of 16	TR010063 – APP 2.11	C01
Biodiversity Sites and Features Plan – Sheet 8 of 16	TR010063 – APP 2.11	C01
Biodiversity Sites and Features Plan – Sheet 9 of 16	TR010063 – APP 2.11	C01
Biodiversity Sites and Features Plan – Sheet 10 of 16	TR010063 – APP 2.11	C01

1.2. List of drawings in Part 2



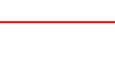

Document Title	Document Number	Revision
Biodiversity Sites and Features Plan – Sheet 11 of 16	TR010063 – APP 2.11	C01
Biodiversity Sites and Features Plan – Sheet 12 of 16	TR010063 – APP 2.11	C01
Biodiversity Sites and Features Plan – Sheet 13 of 16	TR010063 – APP 2.11	C01
Biodiversity Sites and Features Plan – Sheet 14 of 16	TR010063 – APP 2.11	C01
Biodiversity Sites and Features Plan – Sheet 15 of 16	TR010063 – APP 2.11	C01
Biodiversity Sites and Features Plan – Sheet 16 of 16	TR010063 – APP 2.11	C01



NOTES:

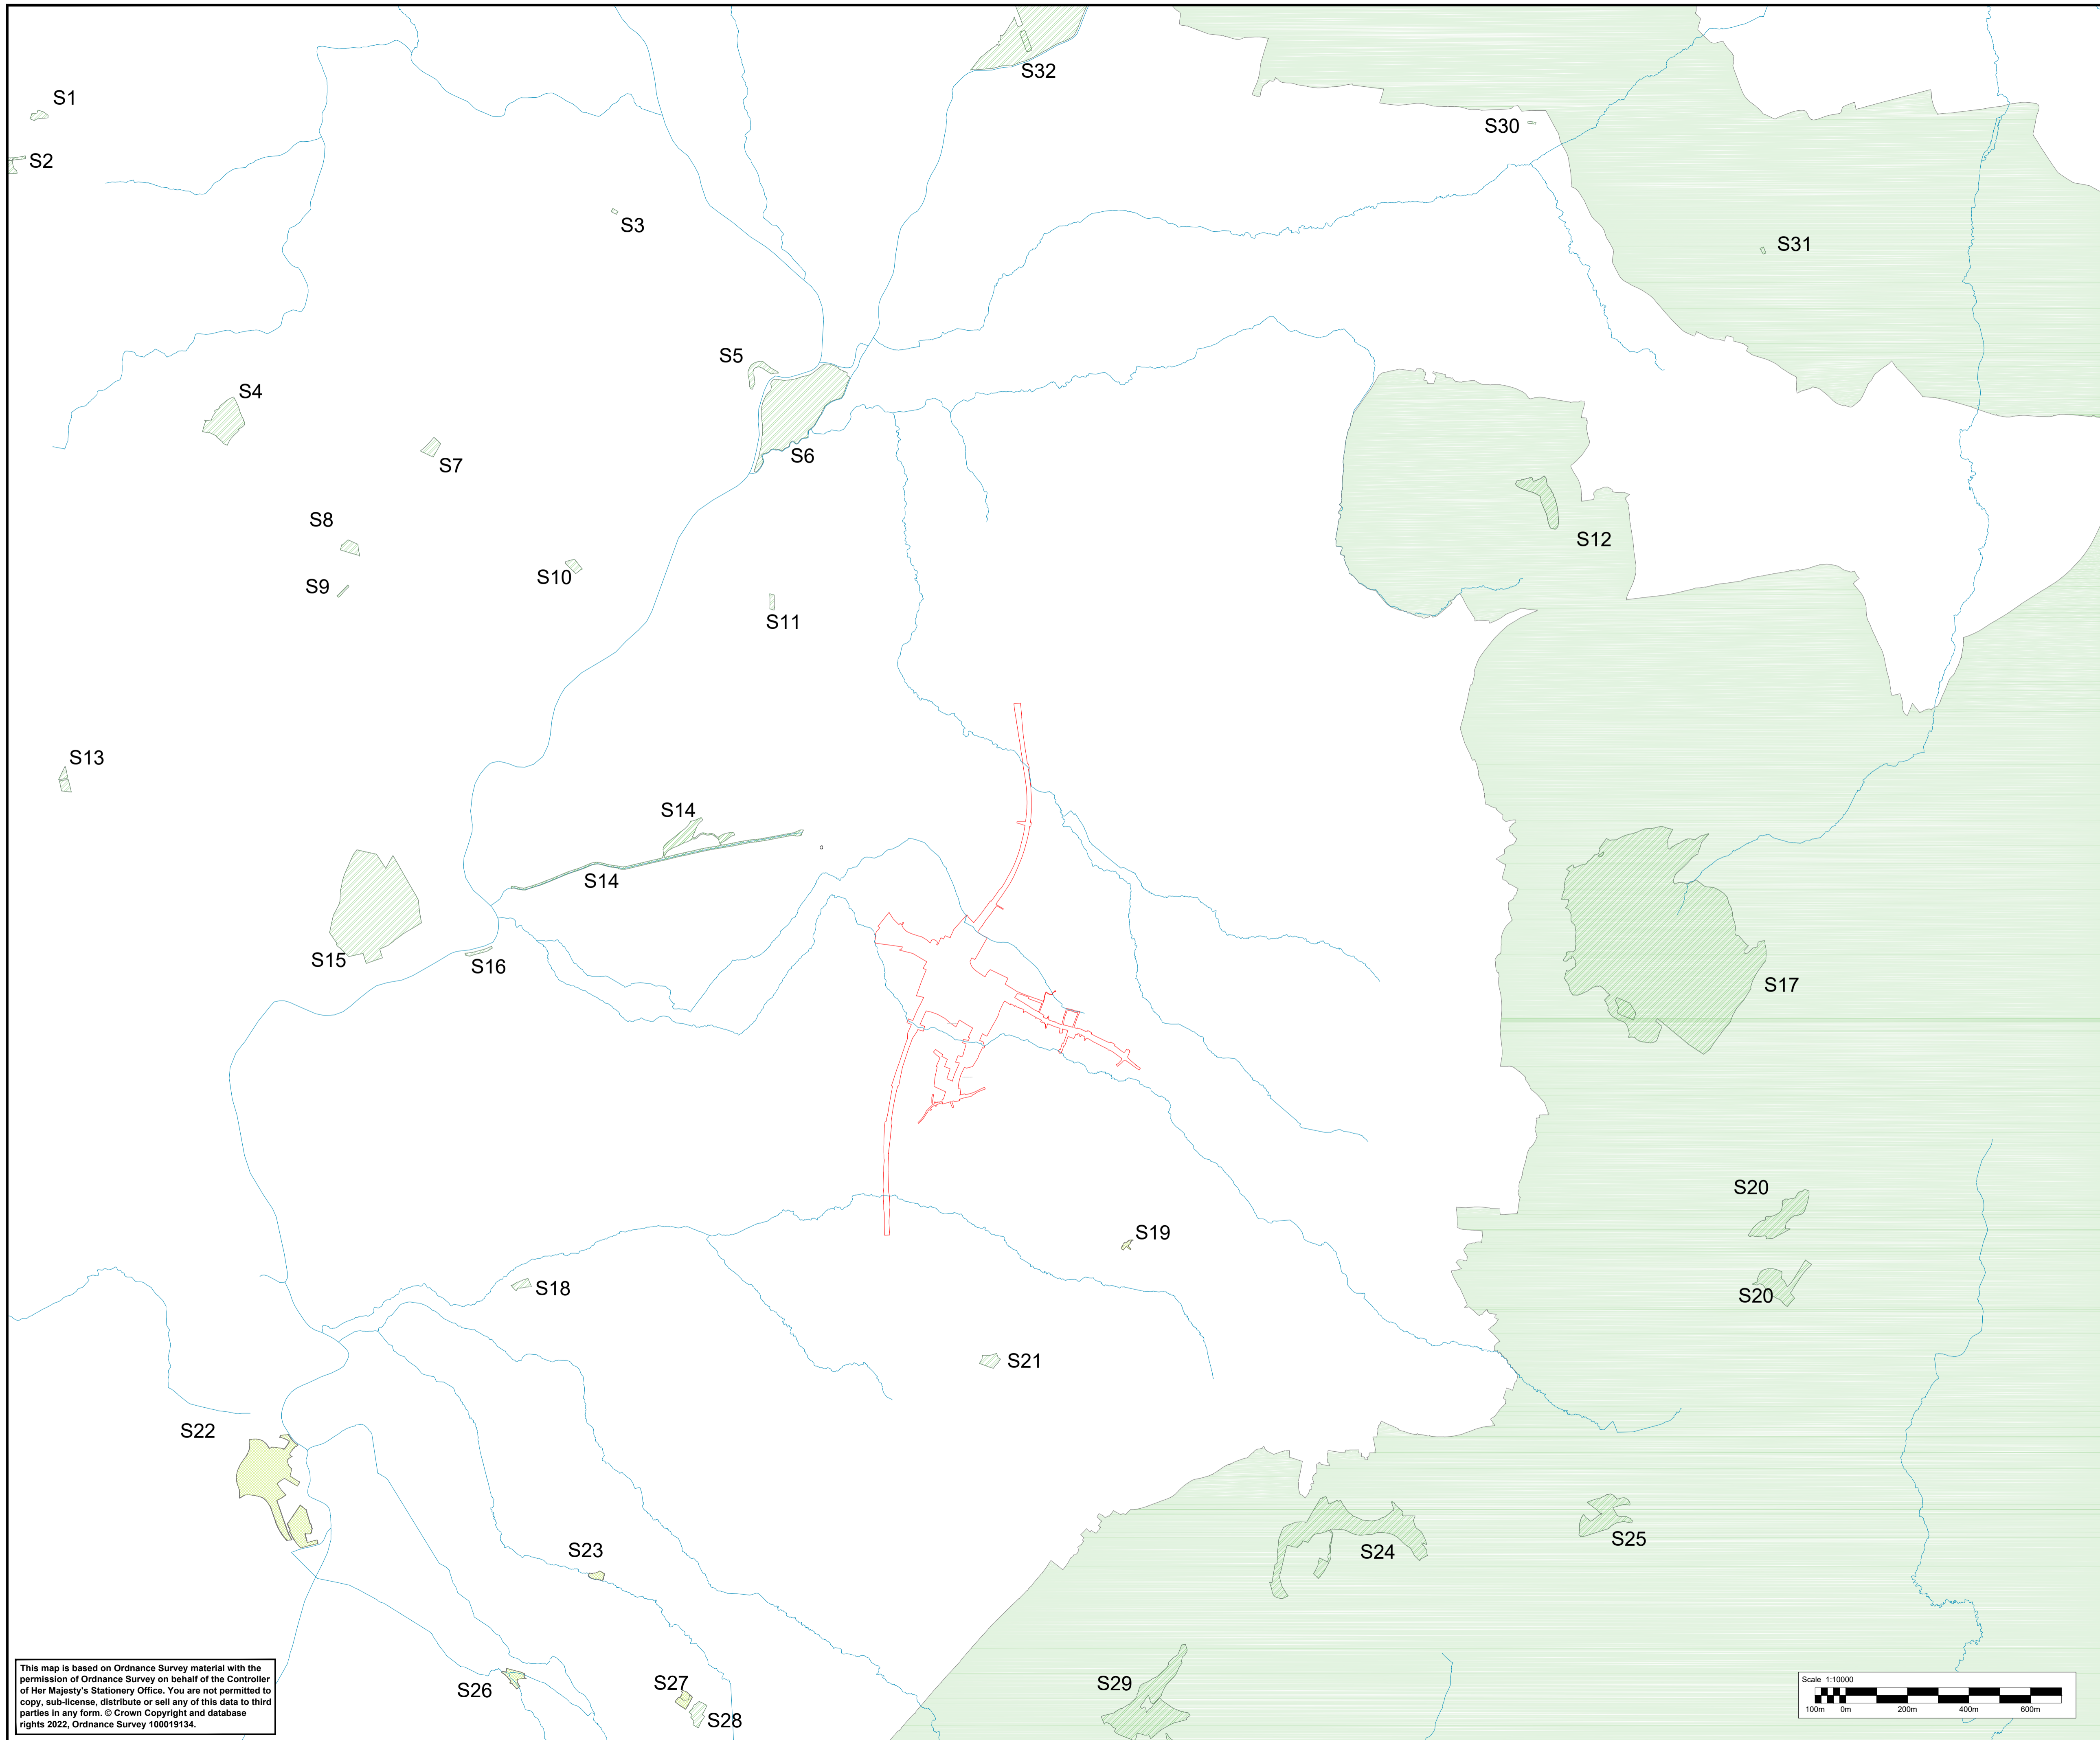
1. ALL DIMENSIONS ARE IN METRES UNLESS OTHERWISE STATED.
2. THE WORKS PLANS SHOULD BE READ IN CONJUNCTION WITH THE DEVELOPMENT CONSENT ORDER.

KEY:

-  SHEET USED AS PART OF THIS DRAWING SERIES.
-  EXISTING ORDNANCE SURVEY DATA
-  DEVELOPMENT CONSENT ORDER (DCO) BOUNDARY
-  SCHEME EXTENT

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

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A1	C01	AC	SS	CDC	BM	17/10/23	
Drawing Suitability						Status	
APPROVED - PUBLISHED						A1	
Project Title							
M5 Junction 10 Improvements Scheme							
Drawing Title							
BIODIVERSITY SITES AND FEATURES PLAN							
KEY PLAN							
Drawing Number							
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




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1. ALL DIMENSIONS ARE IN METRES UNLESS OTHERWISE STATED.
2. THE WORKS PLANS SHOULD BE READ IN CONJUNCTION WITH THE DEVELOPMENT CONSENT ORDER.

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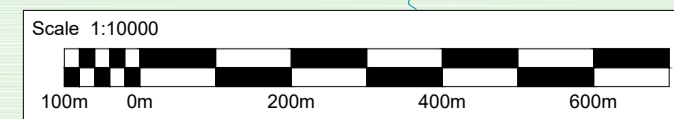
 SHEET XX
 DEVELOPMENT CONSENT ORDER (DCO) BOUNDARY

-  Site of Special Scientific Interest (SSSI)
-  Local Natural Reserves (LNR)
-  Area of Outstanding Natural Beauty (AONB)

- S1 - Barn Meadow SSSI
- S2 - Merries Farm Meadows SSSI
- S3 - Windmill Tump SSSI
- S4 - Burley Dene Meadows SSSI
- S5 - Old River Severn, Upper Lode, SSSI
- S6 - Severn Ham, Tewkesbury SSSI
- S7 - Coombhill Meadows SSSI
- S8 - Poolhay Meadows SSSI
- S9 - Avenue Meadow SSSI
- S10 - Chaceley Meadow SSSI
- S11 - Turvey's Piece SSSI
- S12 - Dixton Wood SSSI and SAC
- S13 - Oridge Street Meadows SSSI
- S14 - Coombe Hill Canal SSSI
- S15 - Ashleworth Ham SSSI
- S16 - Wainlode Cliff SSSI
- S17 - Cleeve Common SSSI
- S18 - Innsworth Meeadow SSSI
- S19 - Griffiths Avenue SSSI
- S20 - Puckham Woods SSSI
- S21 - Badgeworth SSSI
- S22 - Alney Island LNR
- S23 - Barnwood Arboretum LNR
- S24 - Leckhampton Hill and Charlton Kings Common SSSI
- S25 - Lineover Wood SSSI
- S26 - Saintbridge Balancing Pond LNR
- S27 - Hucclecote Meadows LNR
- S28 - Hucclecote Meadows SSSI
- S29 - Crickley Hill and Barrow Wake SSSI
- S30 - Beckford Gravel Pit SSSI
- S31 - Alderton Hill Quarry SSSI
- S32 - Upham Meadow and Summer Leasow SSSI

Description						
Status	Revision	Drawn	Checked	Reviewed	Authorised	Issue Date
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Design Fix 3 - Final (Bus Lane Update)						
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S3	P01	AC	SS	VA	---	04/07/23
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A1	C01	AC	SS	CDC	BM	17/10/23
Drawing Suitability						Status
APPROVED - PUBLISHED						A1
Project Title						
M5 Junction 10 Improvements Scheme						
Drawing Title						
<p style="text-align: center;">BIODIVERSITY SITES AND FEATURES PLAN</p> <p>LARGE SCALE PLAN SHOWING THE SITES NEAREST TO THE SCHEME DESIGNATED FOR BIODIVERSITY OR LANDSCAPE VALUE</p>						
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GCCM5J10	ATK	EBD				
ZZ	DR	LS	000018			
Original Size	Scale	AS SHOWN	Project Ref. No.	Sheet	1 of 1	Rev. C01

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FOR CONTINUATION REFER TO SHEET 1

22.5m

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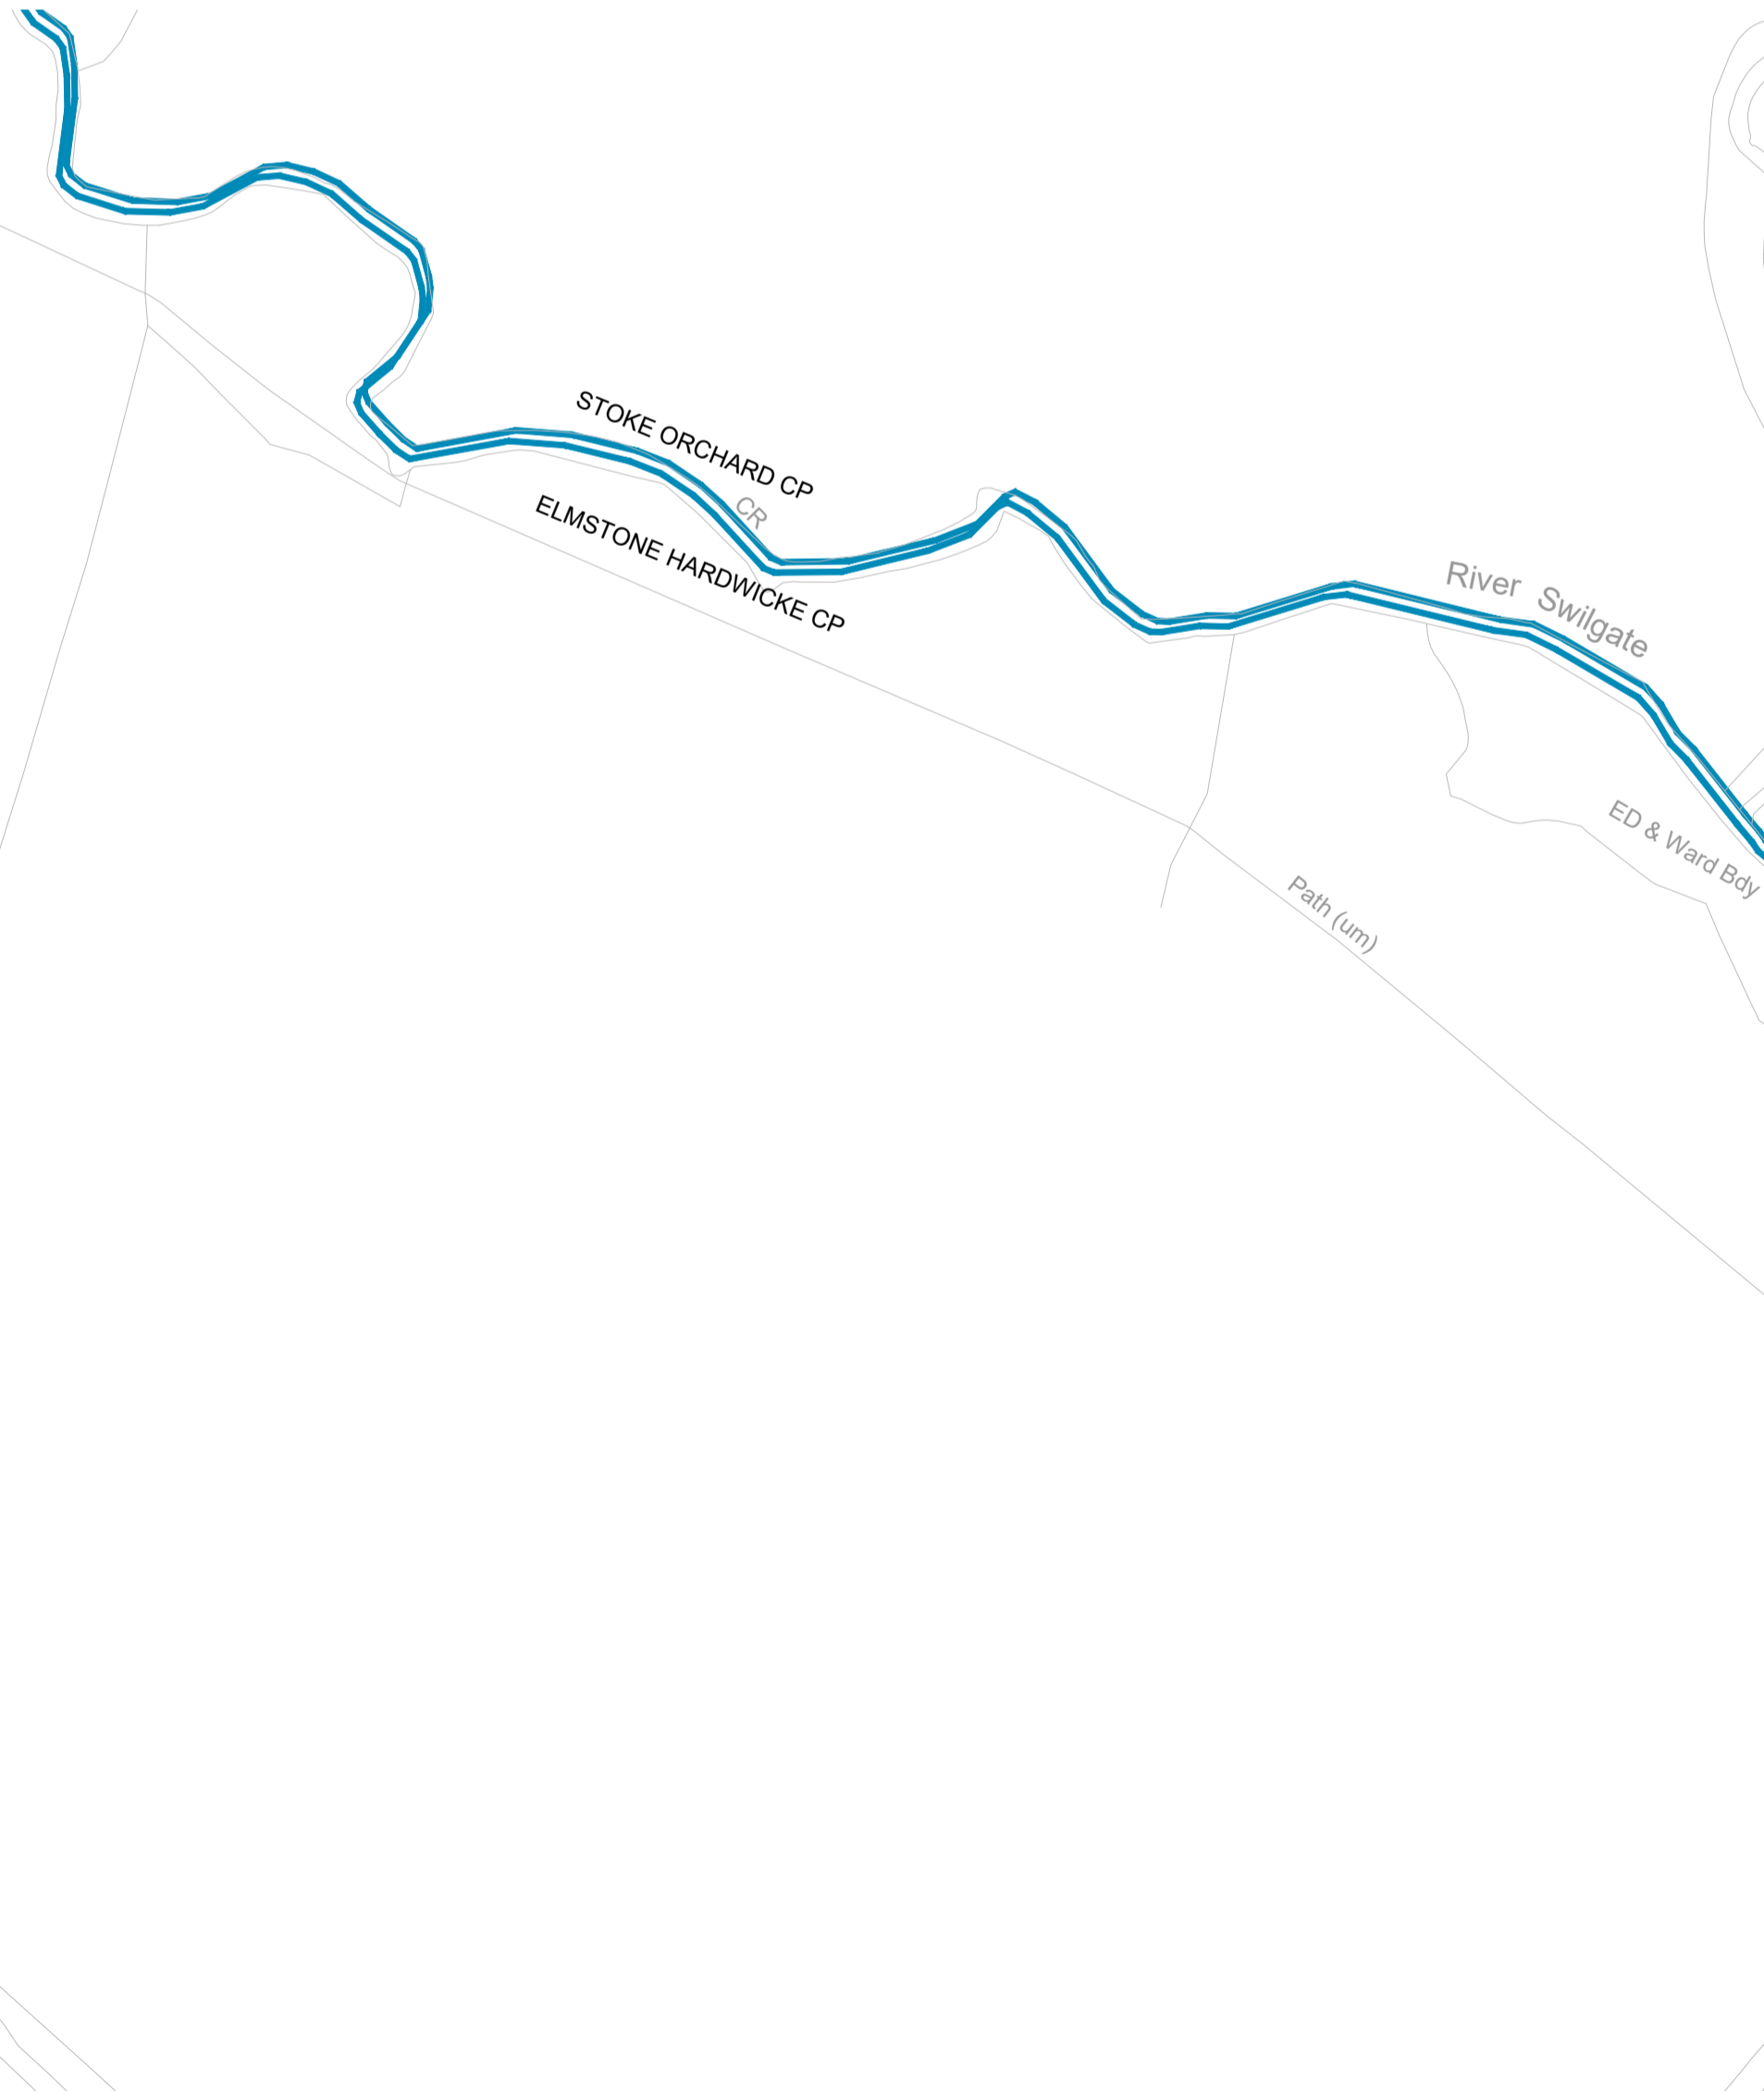
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JUNCTION 9

TOWARDS M5
JUNCTION 10

FOR CONTINUATION REFER TO SHEET 2

M5 MAINLINE

M5 MAINLINE

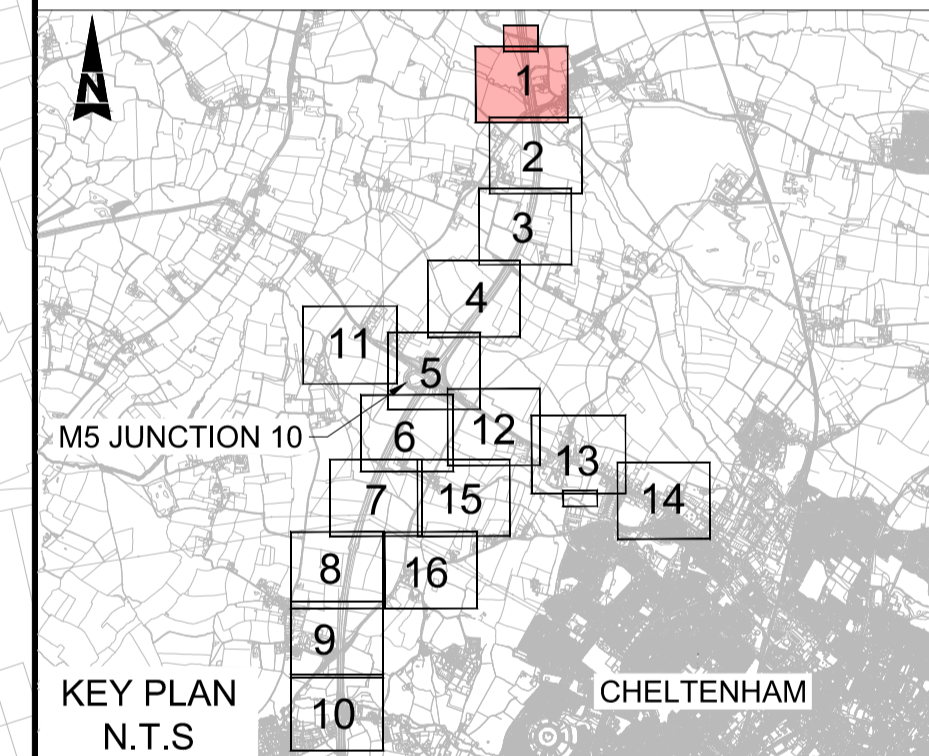


NOTES:

1. ALL DIMENSIONS ARE IN METRES UNLESS OTHERWISE STATED.
2. THE WORKS PLANS SHOULD BE READ IN CONJUNCTION WITH THE DEVELOPMENT CONSENT ORDER.
3. THERE ARE NO SITES WITHIN THE MAP AREA THAT ARE DESIGNATED AS SACS, SPAS, SSSIS, RAMSAR SITES, NNRS, AND LNRS.

KEY

- DEVELOPMENT CONSENT ORDER (DCO) BOUNDARY
- WFD SURFACE WATERBODIES
- 1 IN 1000 YEARS BASELINE FLOODPLAIN
- 1 IN 100 YEARS BASELINE FLOODPLAIN



Description

Status	Revision	Drawn	Checked	Reviewed	Authorised	Issue Date

Description

Status	Revision	Drawn	Checked	Reviewed	Authorised	Issue Date

Description

Status	Revision	Drawn	Checked	Reviewed	Authorised	Issue Date

Description

Status	Revision	Drawn	Checked	Reviewed	Authorised	Issue Date

REVISION 0

Status	Revision	Drawn	Checked	Reviewed	Authorised	Issue Date
A1	C01	AC	SS	CDC	BM	17/10/23

Drawing Suitability

APPROVED - PUBLISHED

Status

A1

Project Title

M5 Junction 10 Improvements Scheme

Drawing Title

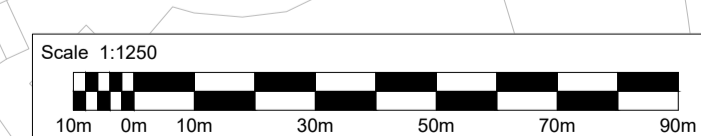
BIODIVERSITY SITES AND FEATURES PLAN

SHEET 1 OF 16

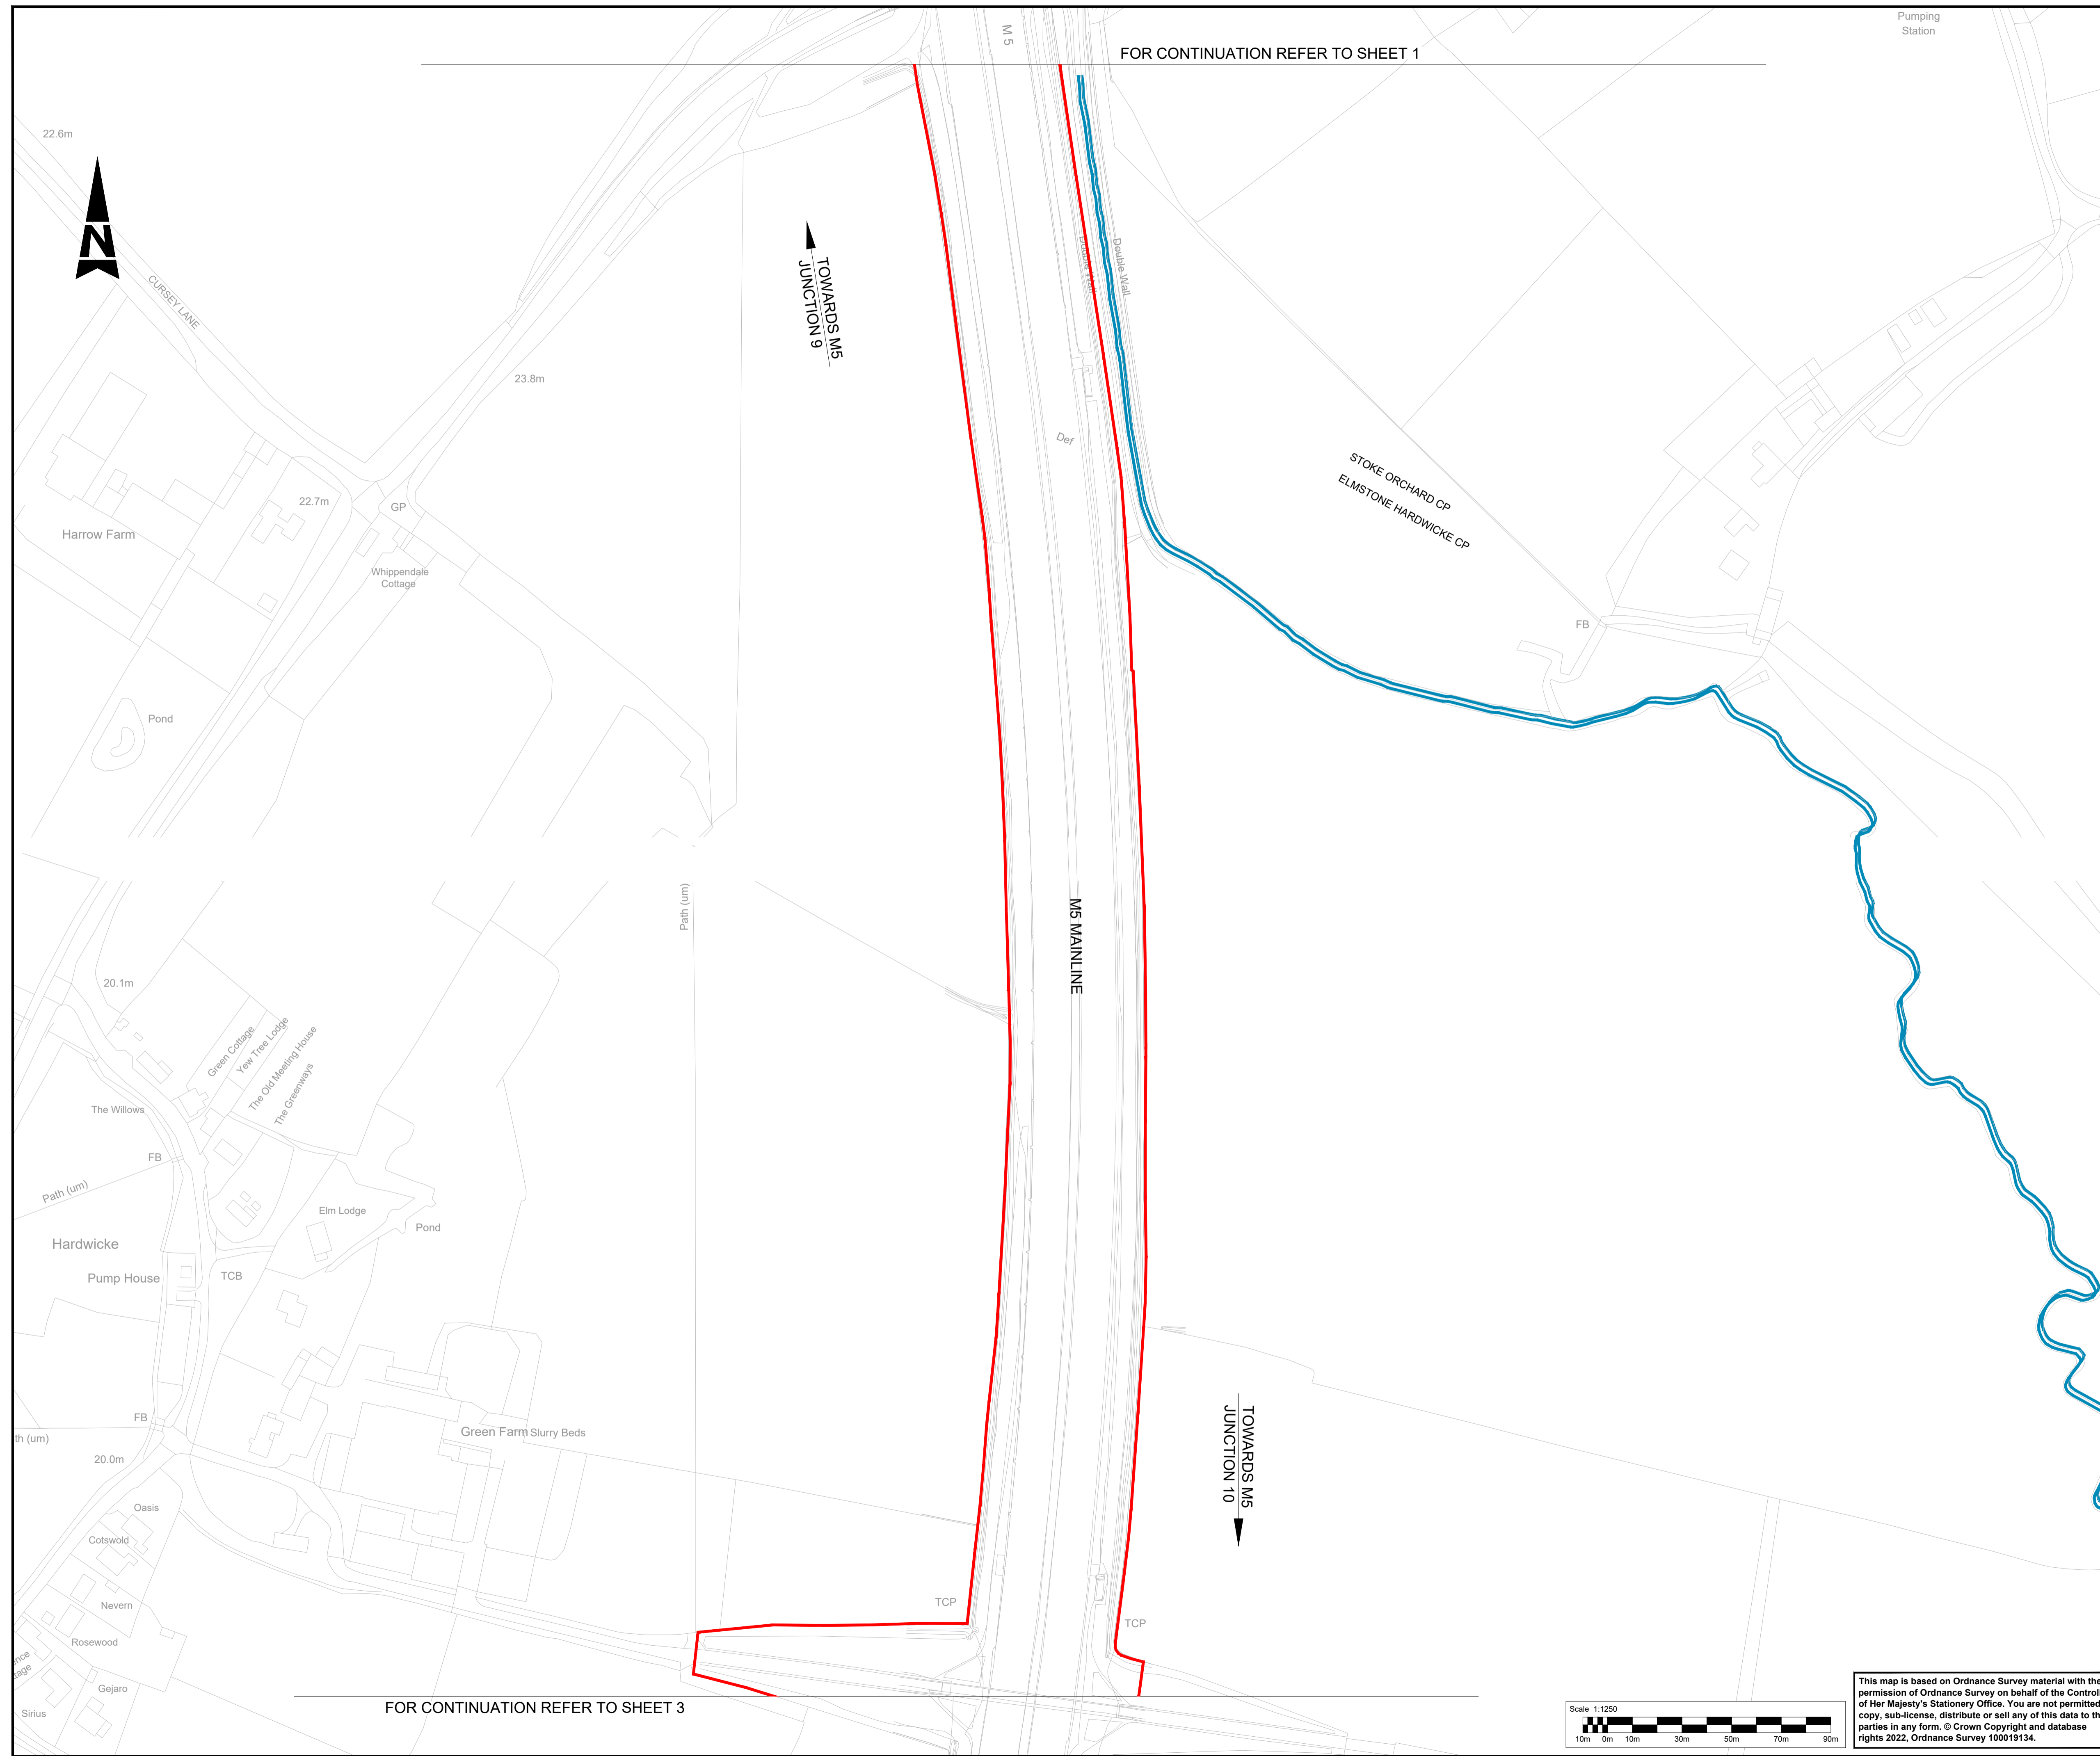
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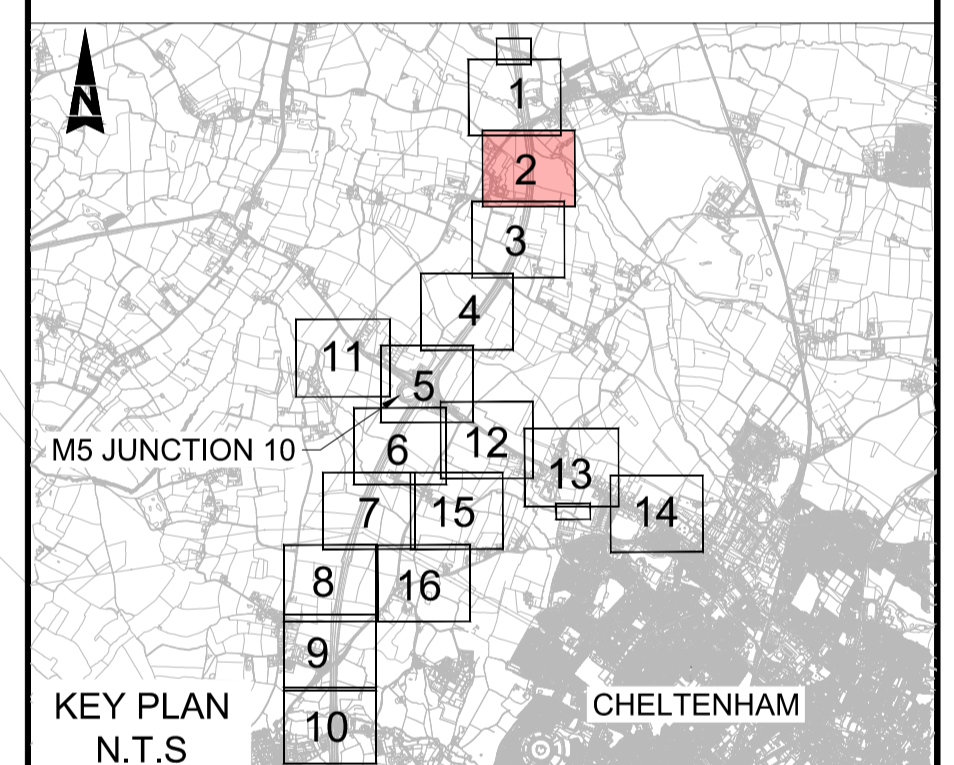


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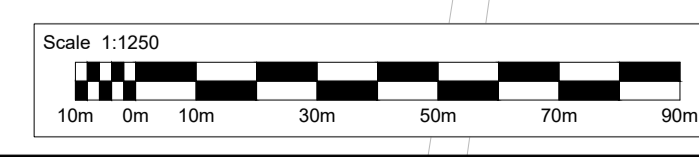
- KEY**
- DEVELOPMENT CONSENT ORDER (DCO) BOUNDARY
 - WFD SURFACE WATERBODIES
 - 1 IN 1000 YEARS BASELINE FLOODPLAIN
 - 1 IN 100 YEARS BASELINE FLOODPLAIN



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A1	C01	AC	SS	CDC	BM	17/10/23
Drawing Suitability						Status
APPROVED - PUBLISHED						A1

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M5 Junction 10 Improvements Scheme						
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BIODIVERSITY SITES AND FEATURES PLAN						
SHEET 2 OF 16						
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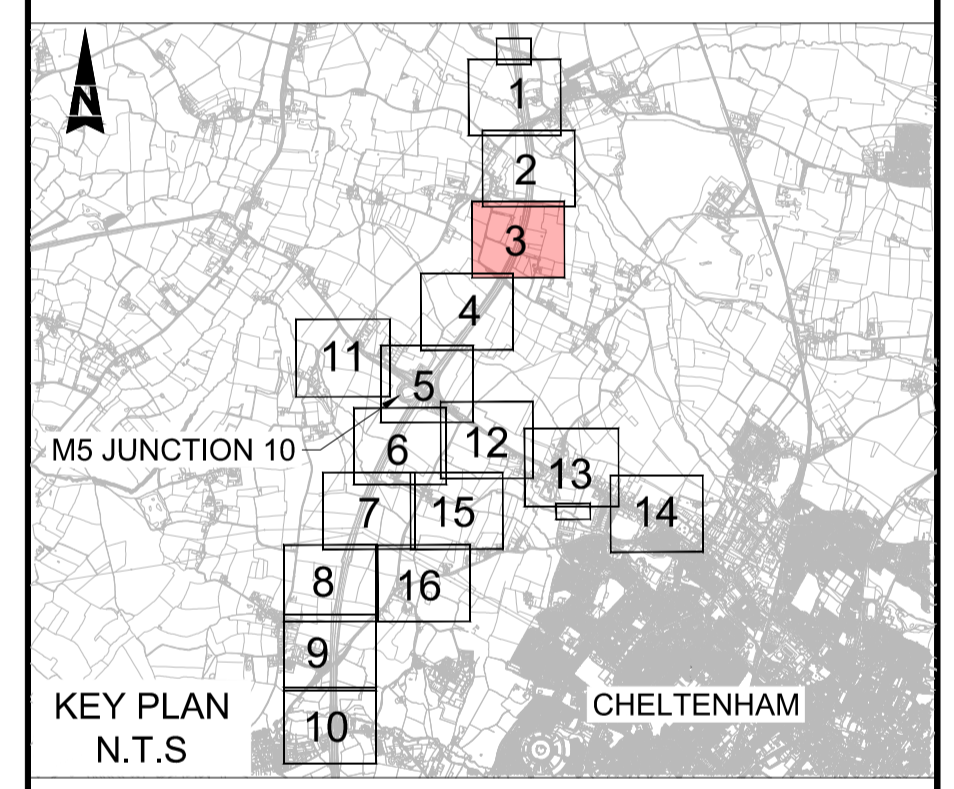
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- KEY**
- DEVELOPMENT CONSENT ORDER (DCO) BOUNDARY
 - WFD SURFACE WATERBODIES
 - 1 IN 1000 YEARS BASELINE FLOODPLAIN
 - 1 IN 100 YEARS BASELINE FLOODPLAIN



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Drawing Suitability						Status
APPROVED - PUBLISHED						A1

Project Title
M5 Junction 10 Improvements Scheme

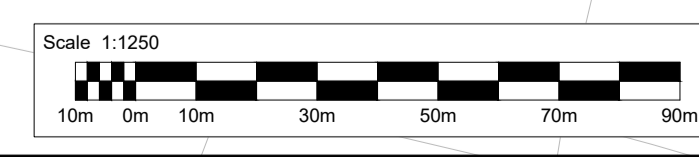
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SHEET 3 OF 16

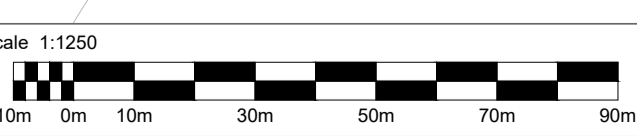
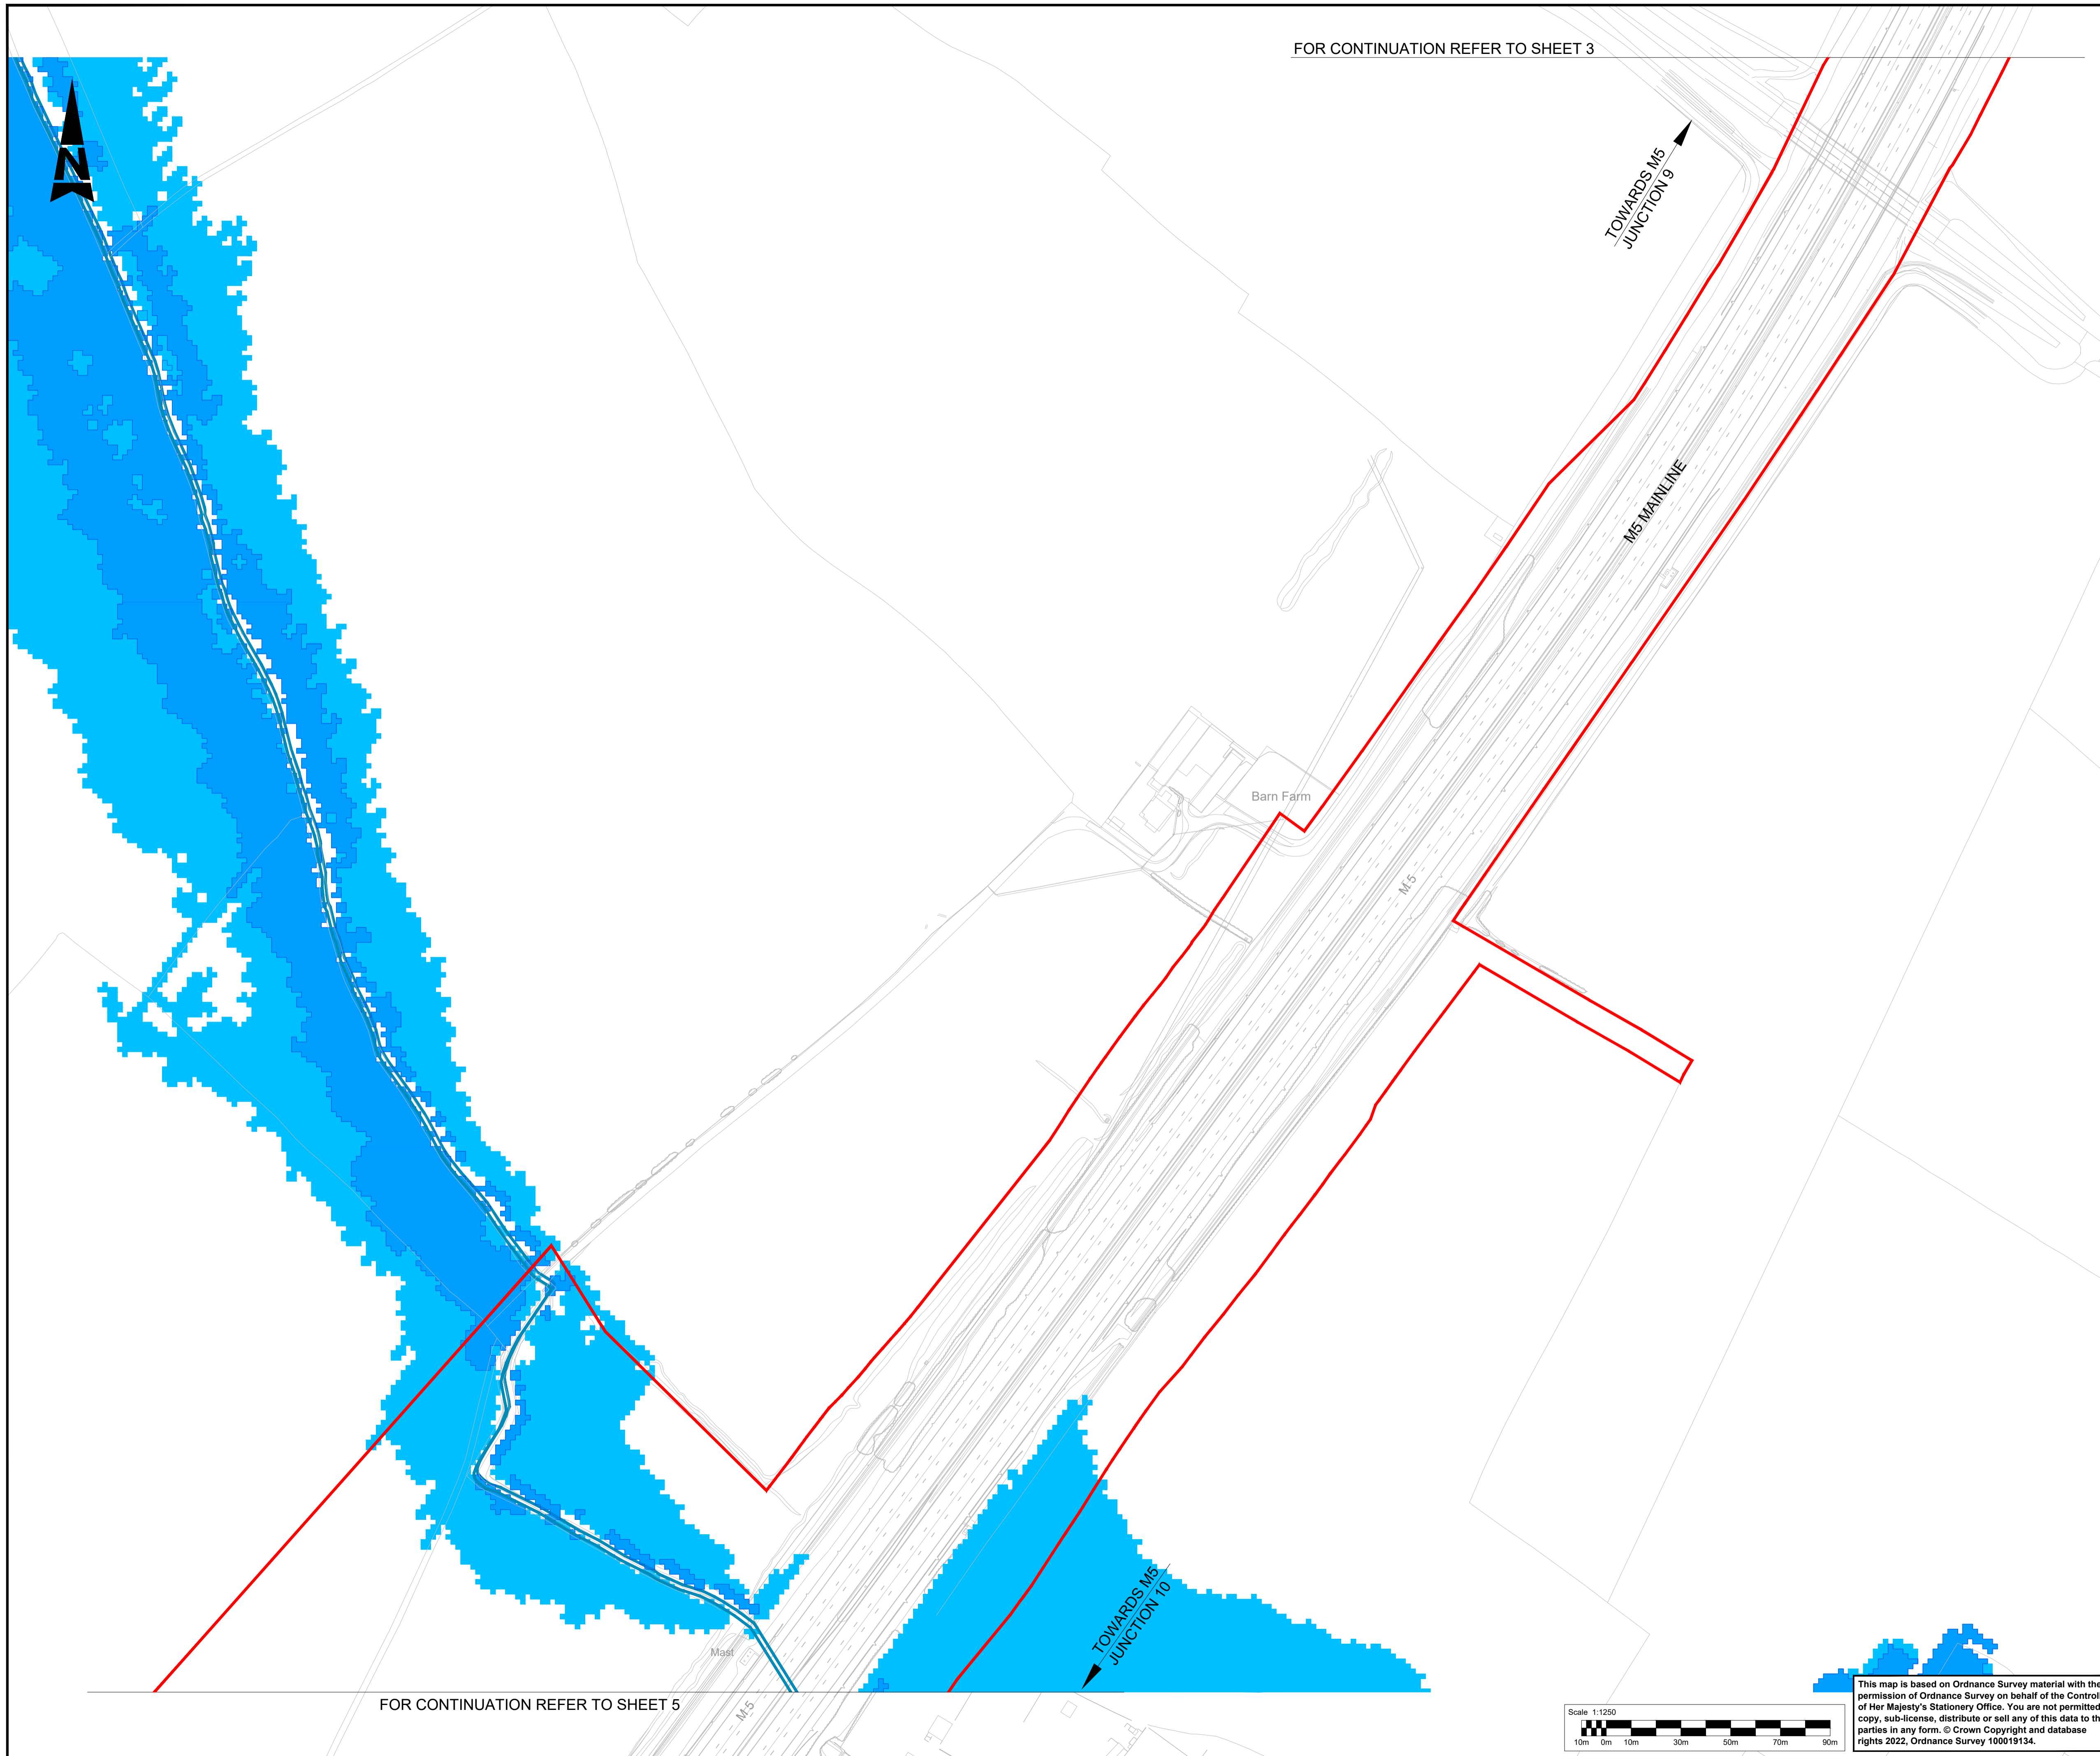
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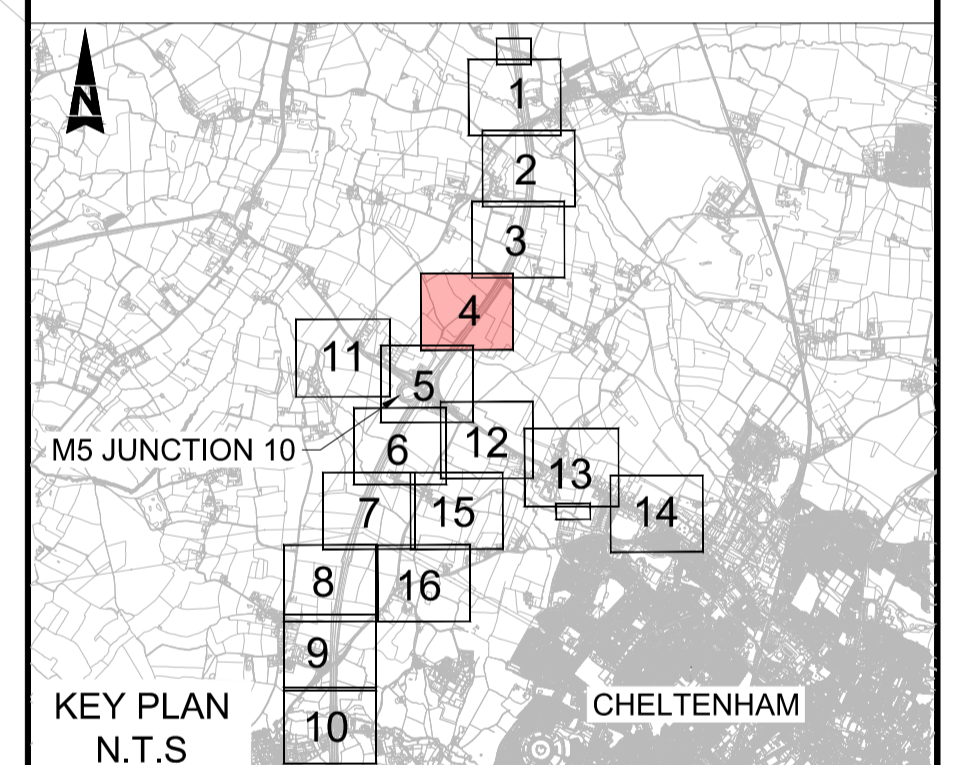
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NOTES:

1. ALL DIMENSIONS ARE IN METRES UNLESS OTHERWISE STATED.
2. THE WORKS PLANS SHOULD BE READ IN CONJUNCTION WITH THE DEVELOPMENT CONSENT ORDER.
3. THERE ARE NO SITES WITHIN THE MAP AREA THAT ARE DESIGNATED AS SACS, SPAS, SSSIS, RAMSAR SITES, NNRS, AND LNRS.

KEY

- DEVELOPMENT CONSENT ORDER (DCO) BOUNDARY
- WFD SURFACE WATERBODIES
- 1 IN 1000 YEARS BASELINE FLOODPLAIN
- 1 IN 100 YEARS BASELINE FLOODPLAIN



Description						
Status	Revision	Drawn	Checked	Reviewed	Authorised	Issue Date
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Drawing Suitability						Status
A1	C01	AC	SS	CDC	BM	17/10/23
APPROVED - PUBLISHED						A1

Project Title
M5 Junction 10 Improvements Scheme

Drawing Title
BIODIVERSITY SITES AND FEATURES PLAN

SHEET 4 OF 16

Drawing Number	GCCM5J10	ATK	EBD
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			Sheet 4 of 16
			Rev. C01



FOR CONTINUATION REFER TO SHEET 4

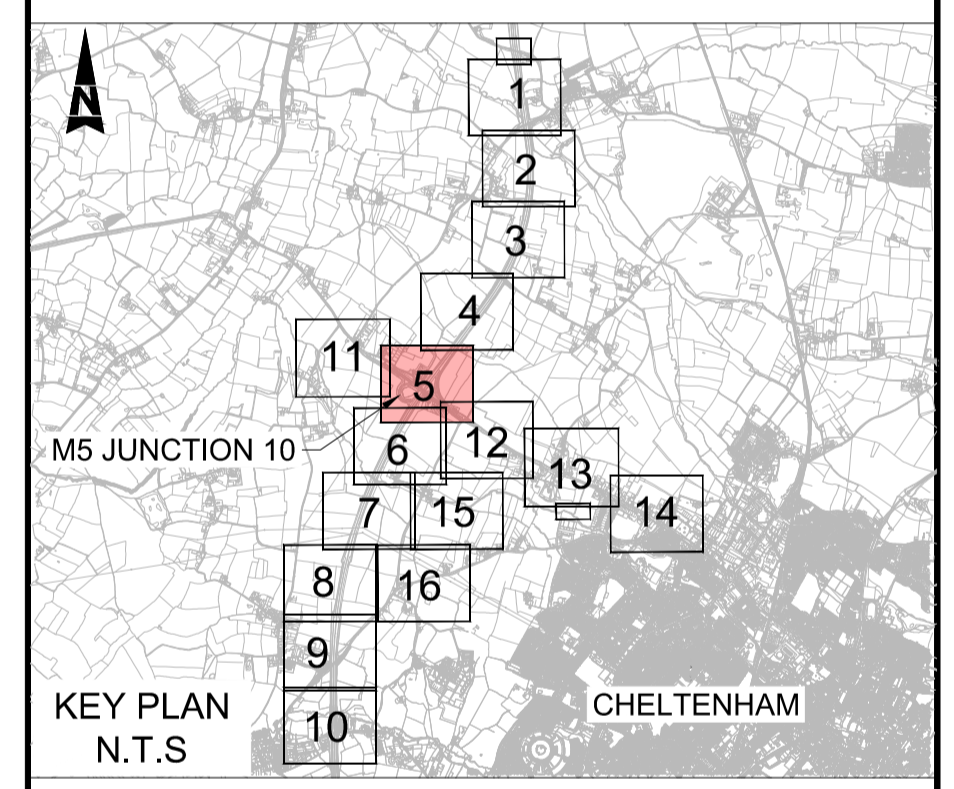
FOR CONTINUATION REFER TO SHEET 11

FOR CONTINUATION REFER TO SHEET 12

FOR CONTINUATION REFER TO SHEET 6

- NOTES:**
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- KEY**
- DEVELOPMENT CONSENT ORDER (DCO) BOUNDARY
 - WFD SURFACE WATERBODIES
 - 1 IN 1000 YEARS BASELINE FLOODPLAIN
 - 1 IN 100 YEARS BASELINE FLOODPLAIN



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A1	CO1	AC	SS	CDC	BM	17/10/23
Drawing Suitability						Status
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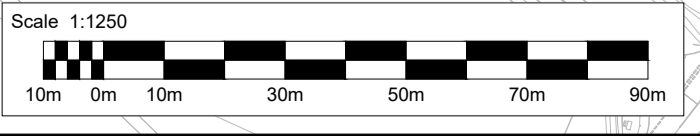
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M5 Junction 10 Improvements Scheme

Drawing Title
BIODIVERSITY SITES AND FEATURES PLAN

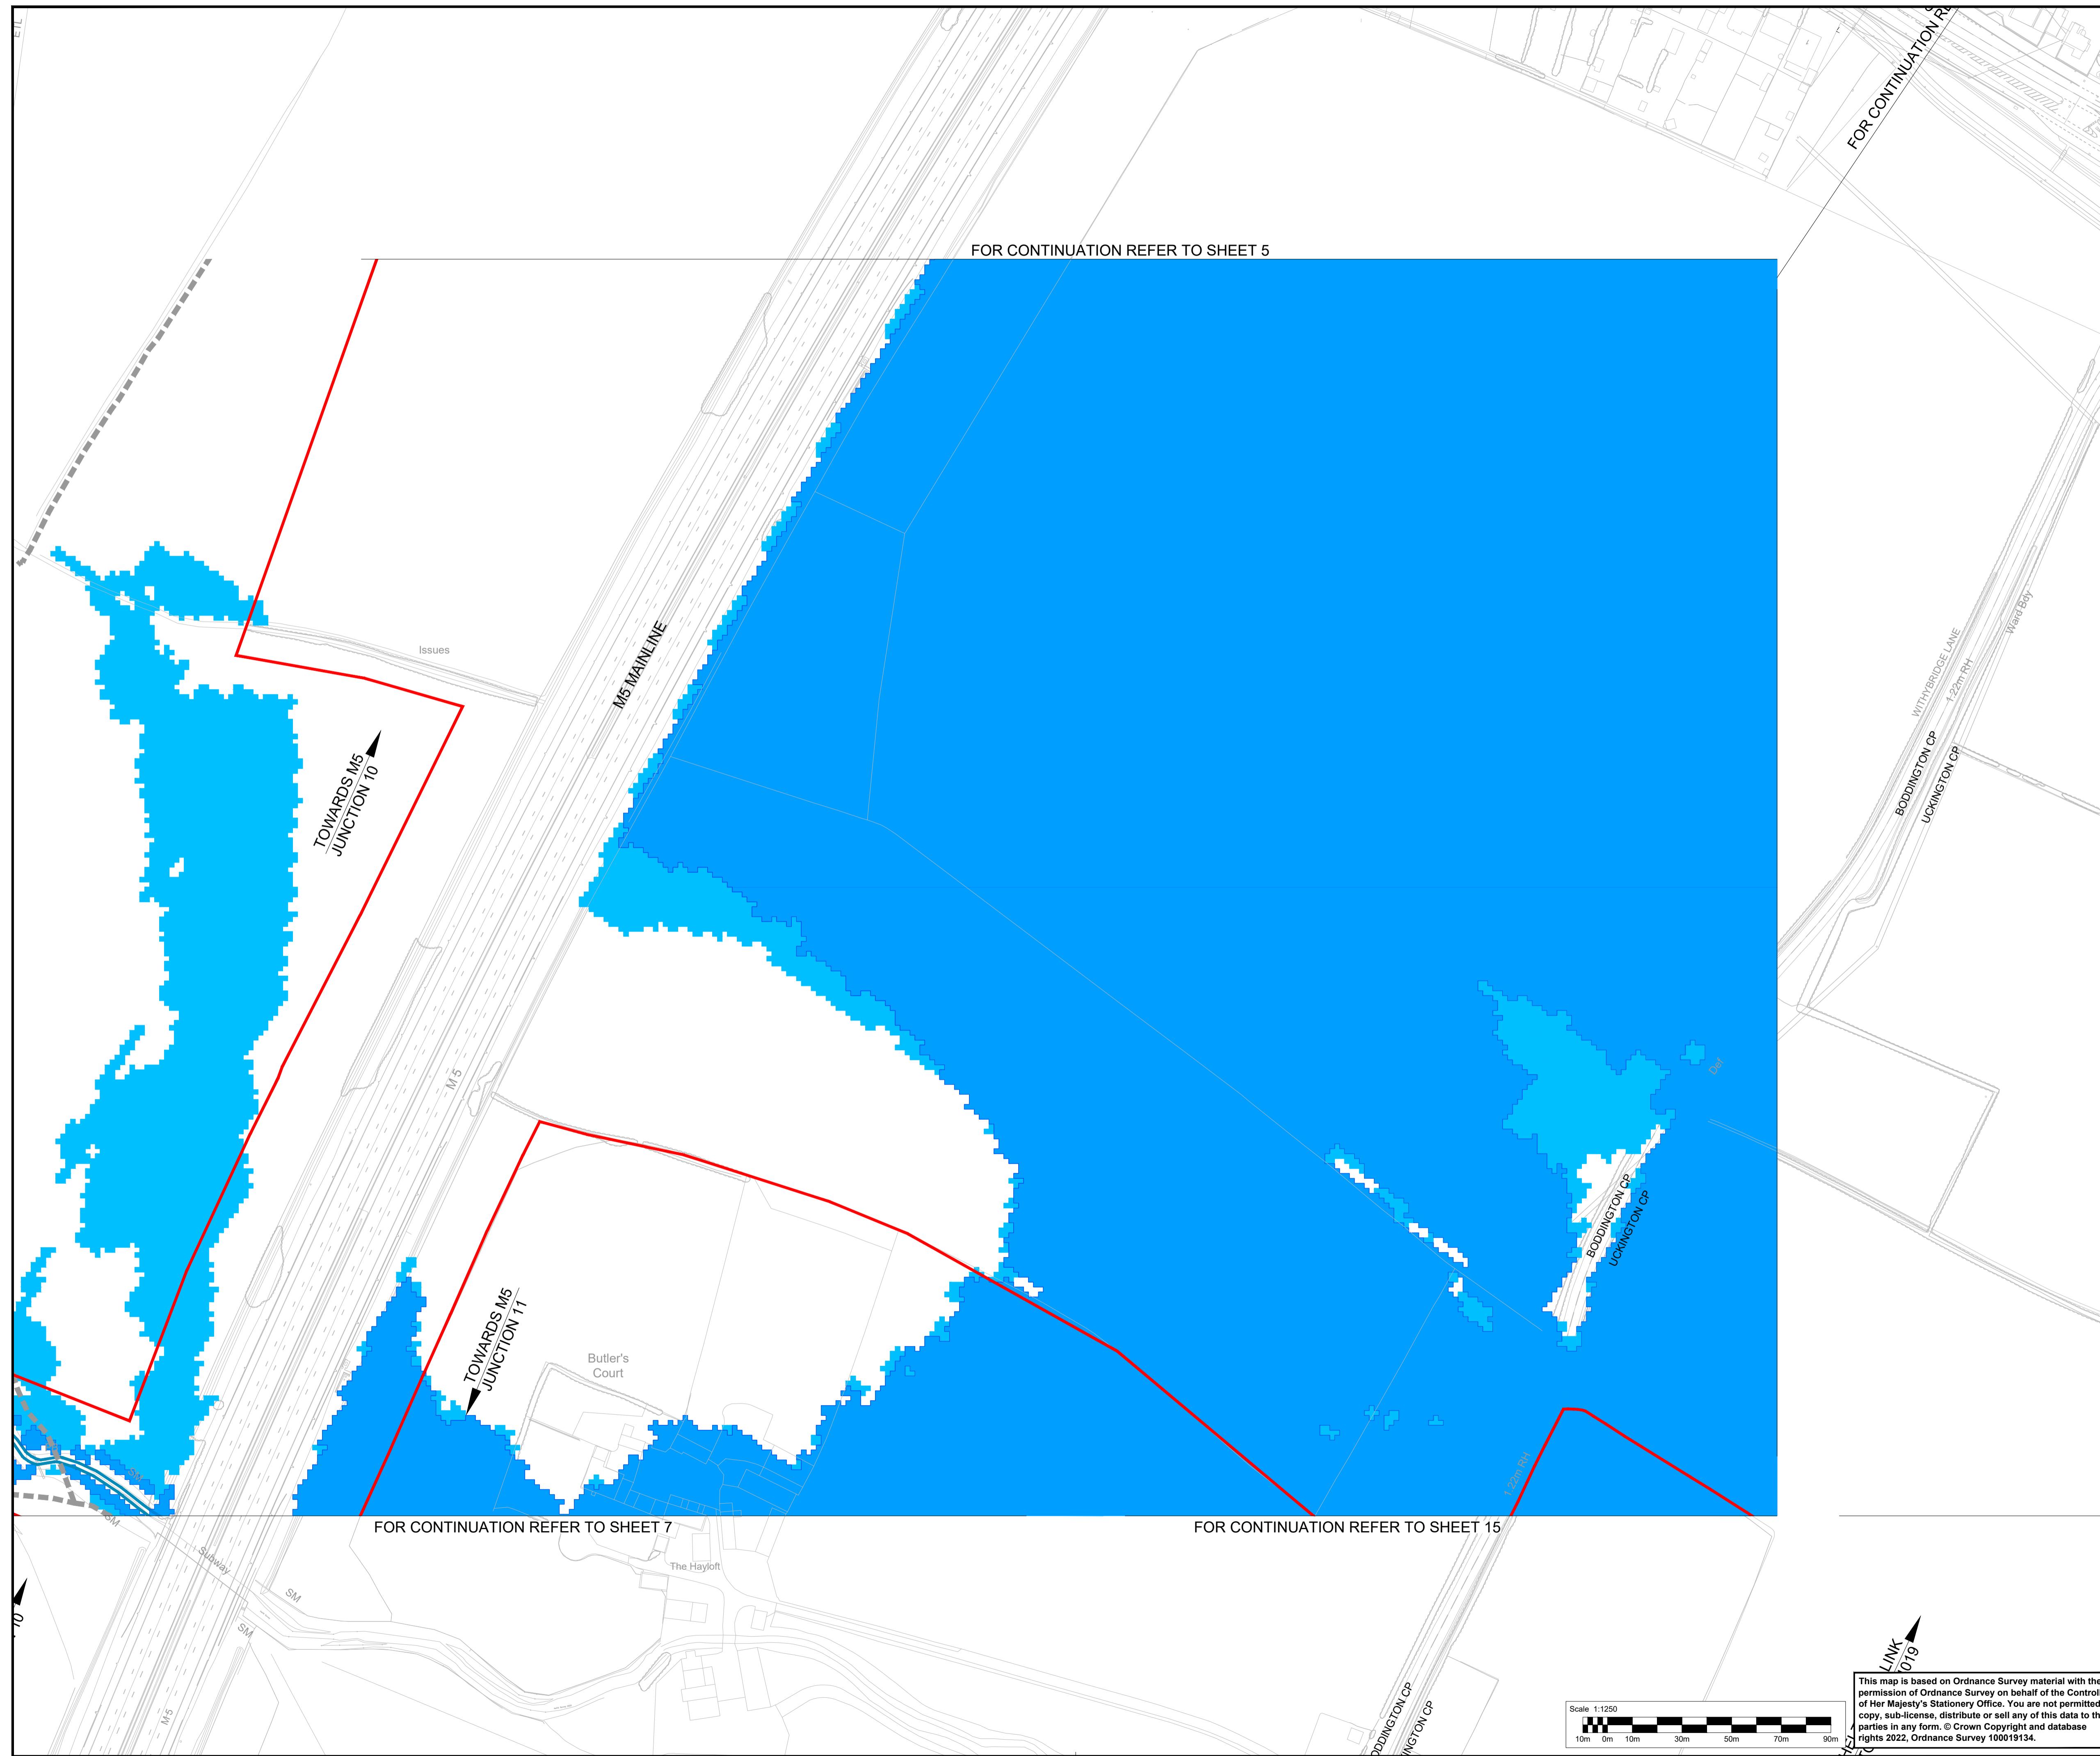
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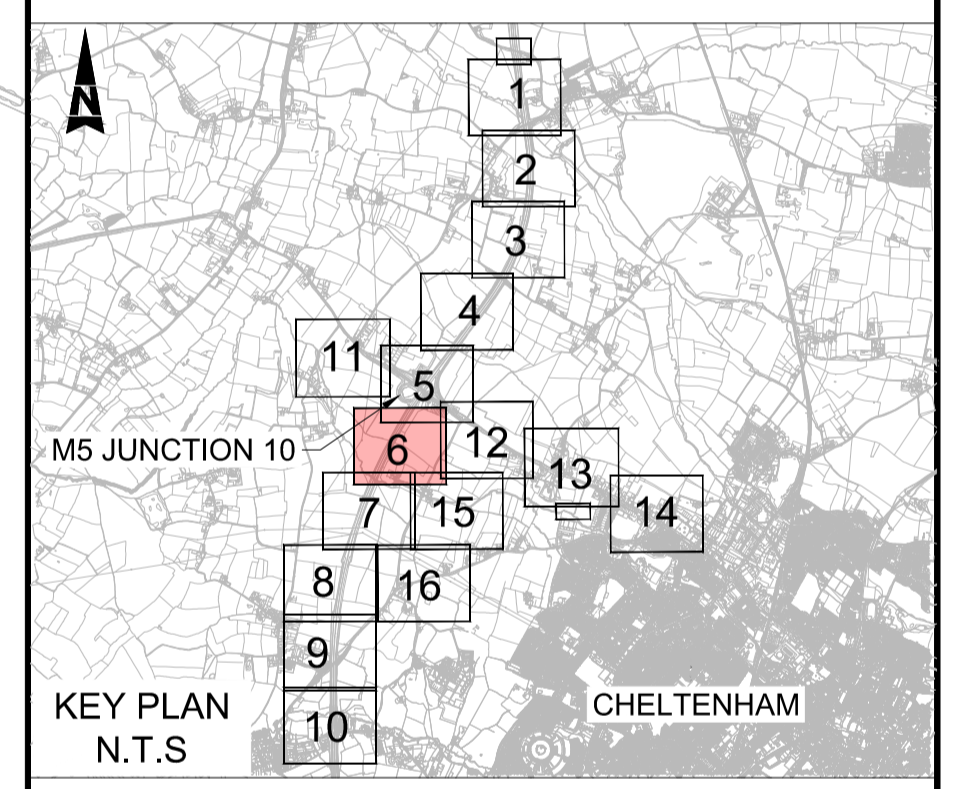


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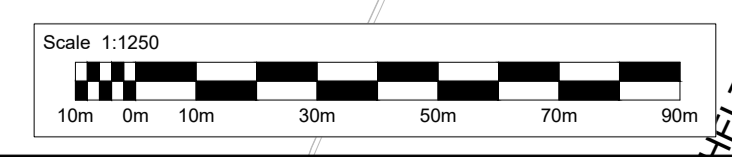
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- DEVELOPMENT CONSENT ORDER (DCO) BOUNDARY
 - WFD SURFACE WATERBODIES
 - 1 IN 1000 YEARS BASELINE FLOODPLAIN
 - 1 IN 100 YEARS BASELINE FLOODPLAIN



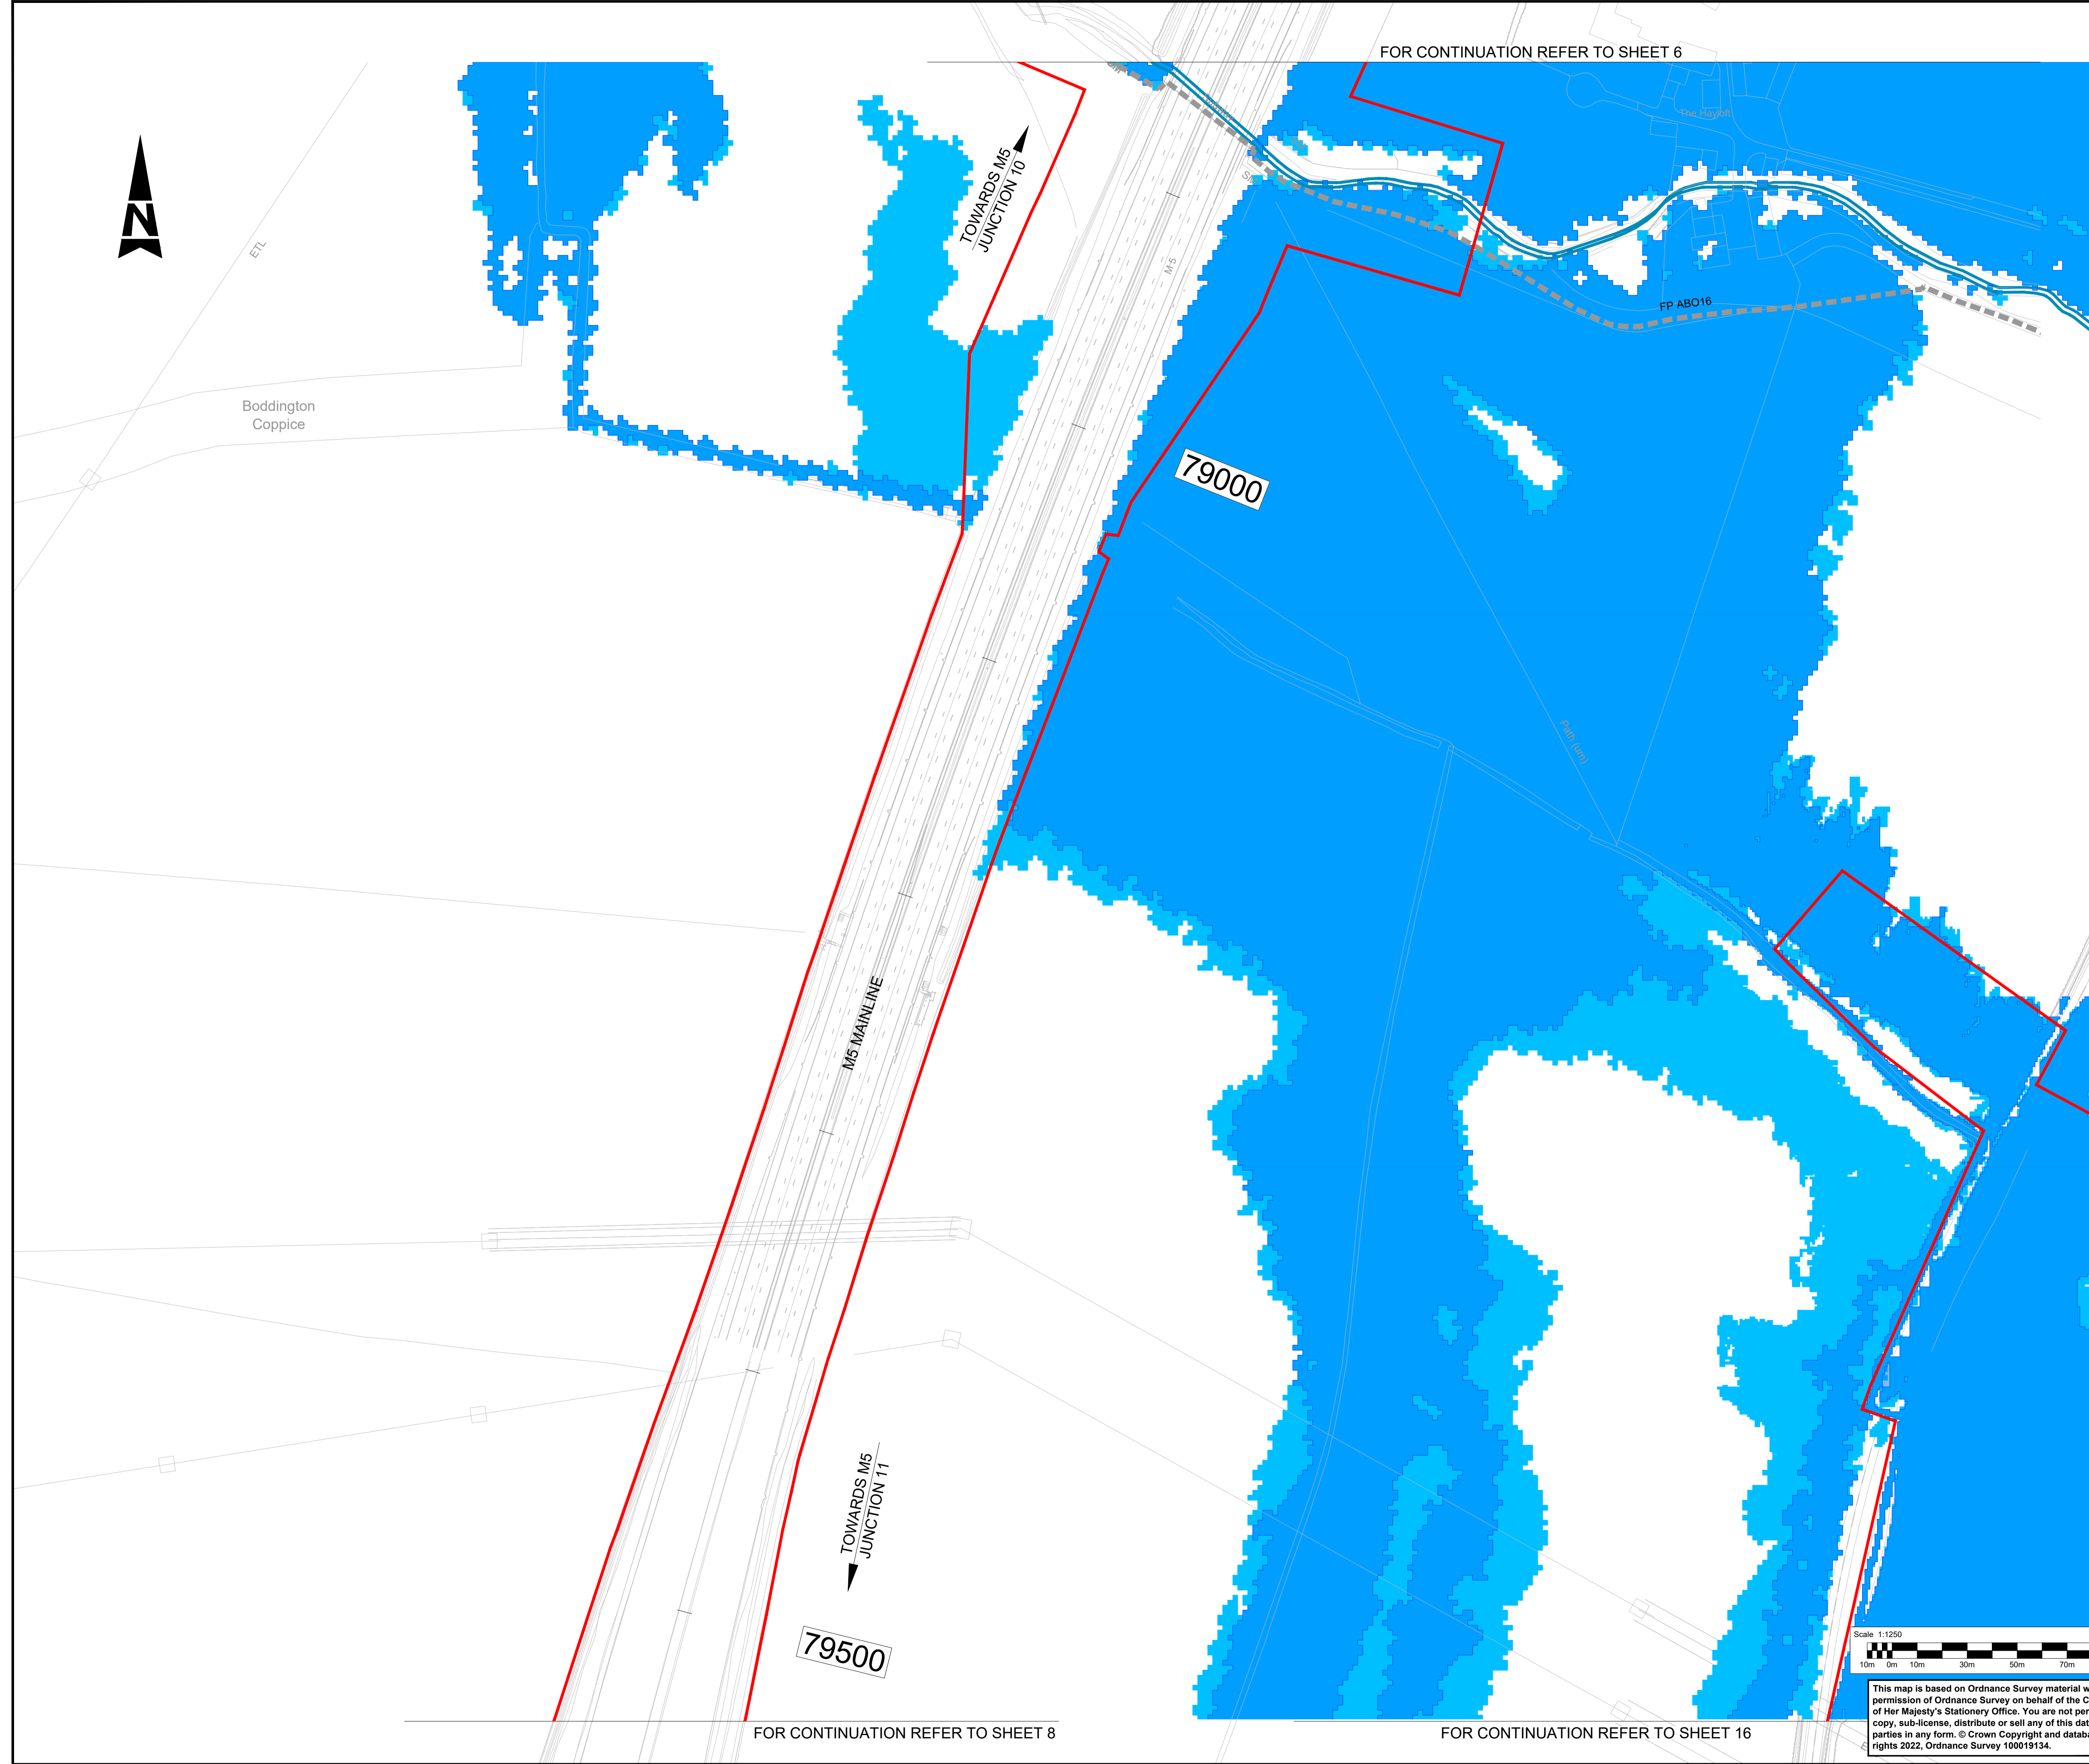
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Drawing Suitability						Status	
APPROVED - PUBLISHED						A1	

Project Title			
M5 Junction 10 Improvements Scheme			
Drawing Title			
BIODIVERSITY SITES AND FEATURES PLAN			
SHEET 6 OF 16			
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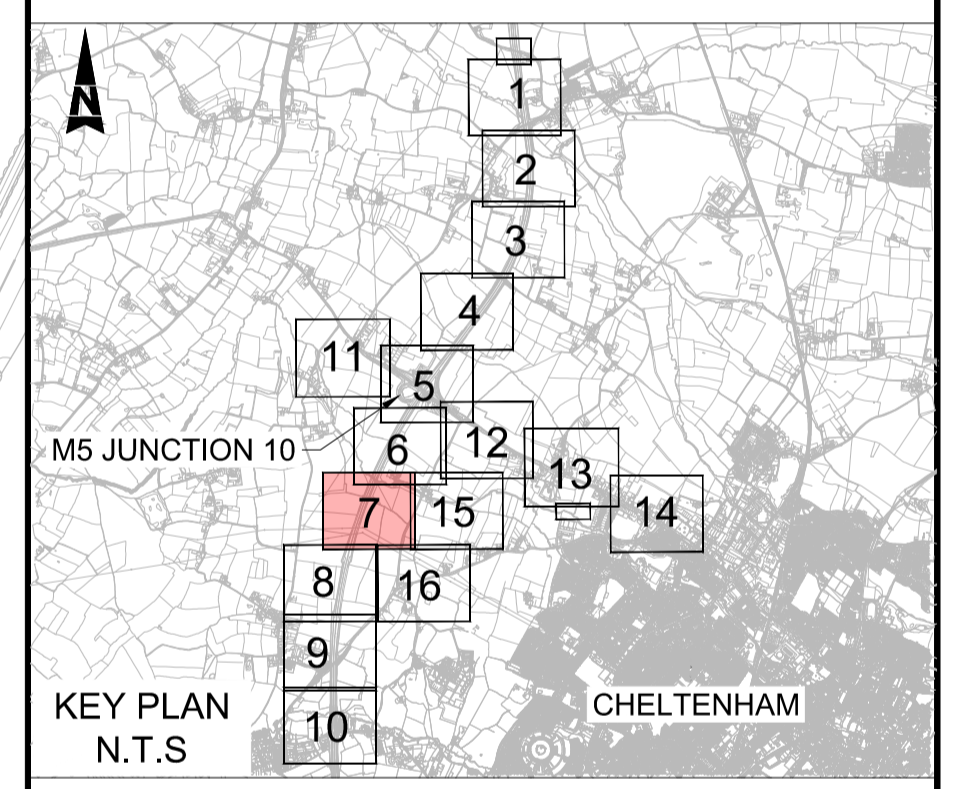
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- KEY**
- DEVELOPMENT CONSENT ORDER (DCO) BOUNDARY
 - WFD SURFACE WATERBODIES
 - 1 IN 1000 YEARS BASELINE FLOODPLAIN
 - 1 IN 100 YEARS BASELINE FLOODPLAIN

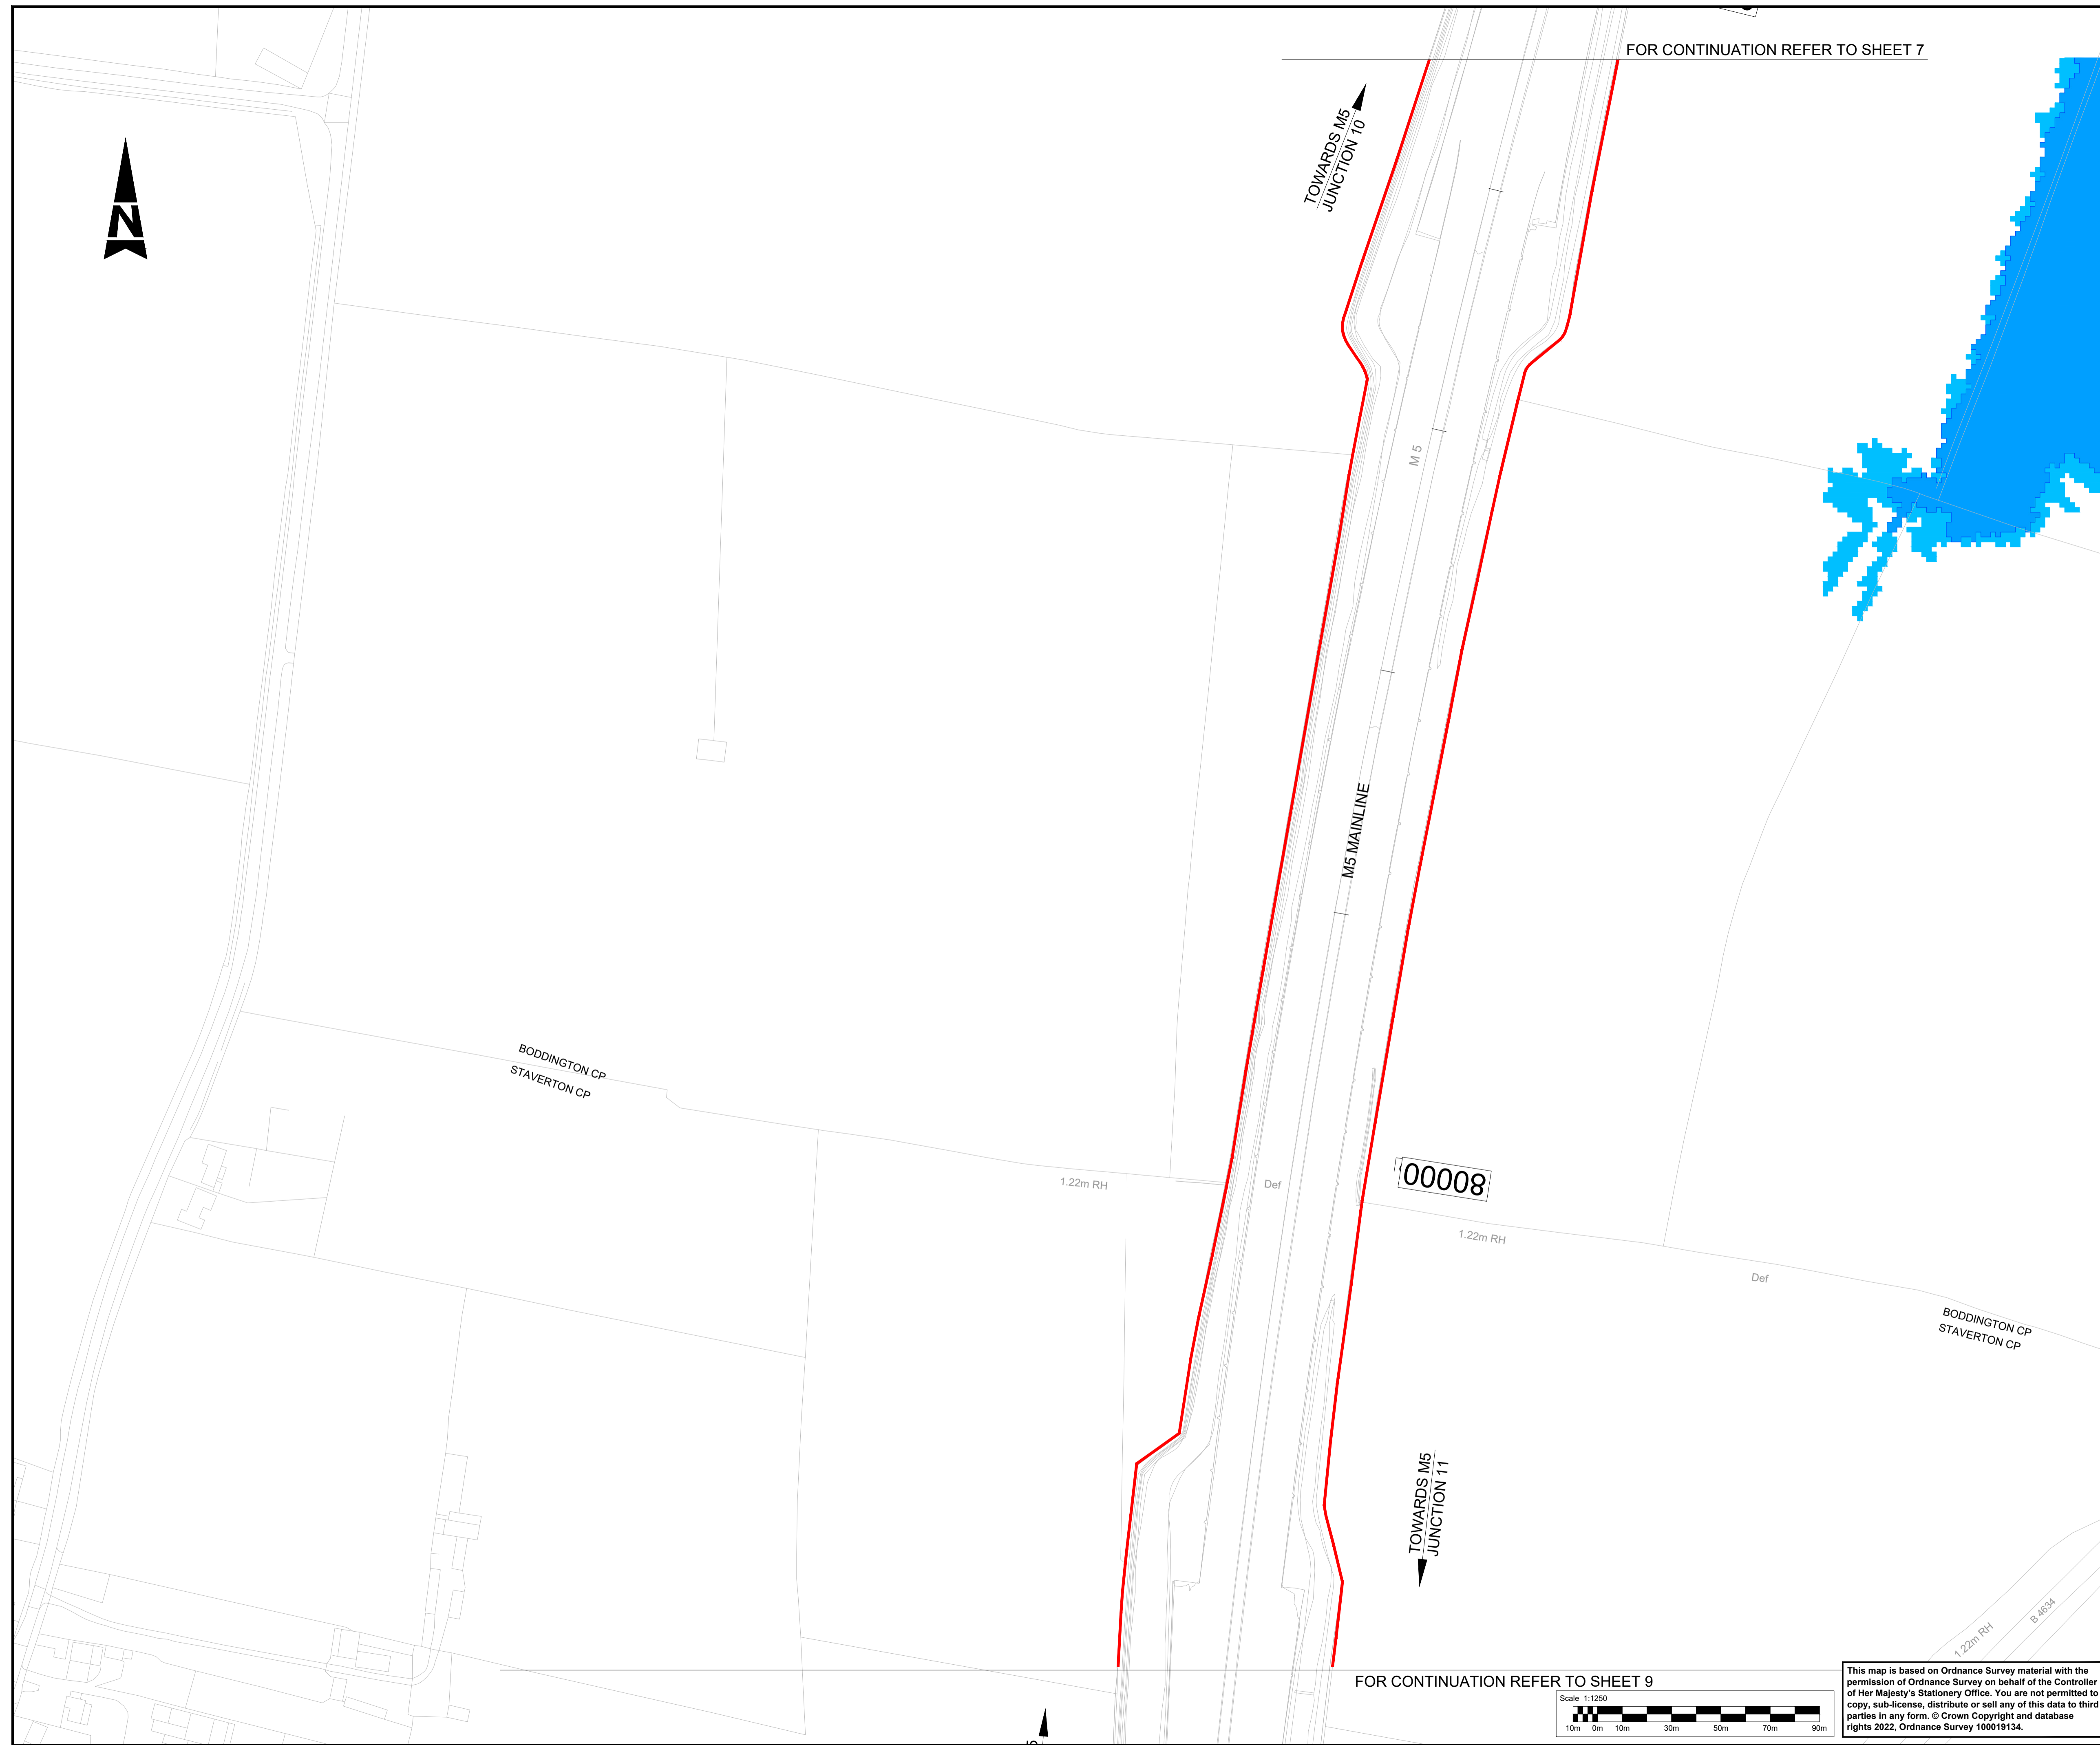


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Drawing Suitability						Status
APPROVED - PUBLISHED						A1

Project Title						
M5 Junction 10 Improvements Scheme						
Drawing Title						
BIODIVERSITY SITES AND FEATURES PLAN						
SHEET 7 OF 16						
Drawing Number						
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Original Size: A1	Scale: AS SHOWN	Project Ref. No: 5197035	Sheet: 7 of 16	Rev: C01		

Scale 1:1250

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FOR CONTINUATION REFER TO SHEET 7

TOWARDS M5 JUNCTION 10

M5 MAINLINE

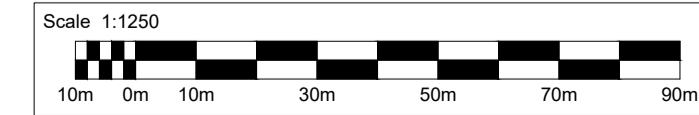
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TOWARDS M5 JUNCTION 11

BODDINGTON CP
STAVERTON CP

BODDINGTON CP
STAVERTON CP

FOR CONTINUATION REFER TO SHEET 9



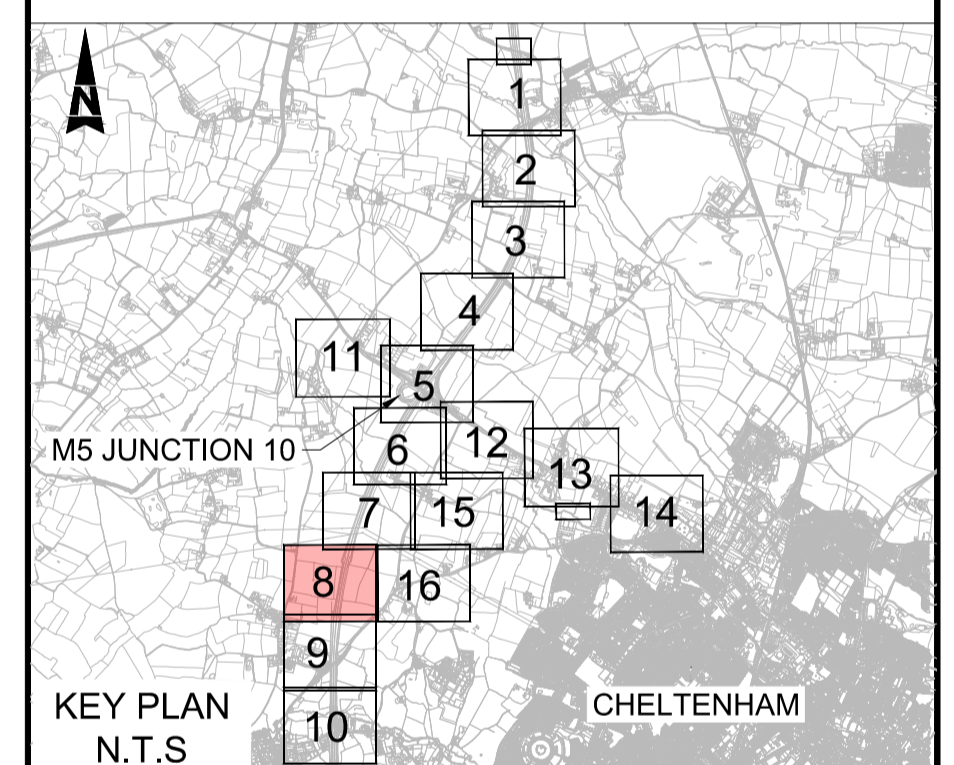
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NOTES:

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2. THE WORKS PLANS SHOULD BE READ IN CONJUNCTION WITH THE DEVELOPMENT CONSENT ORDER.
3. THERE ARE NO SITES WITHIN THE MAP AREA THAT ARE DESIGNATED AS SACS, SPAS, SSSIS, RAMSAR SITES, NNRS, AND LNRS.

KEY

- DEVELOPMENT CONSENT ORDER (DCO) BOUNDARY
- WFD SURFACE WATERBODIES
- 1 IN 1000 YEARS BASELINE FLOODPLAIN
- 1 IN 100 YEARS BASELINE FLOODPLAIN



Description						
Status	Revision	Drawn	Checked	Reviewed	Authorised	Issue Date
Description						
Status	Revision	Drawn	Checked	Reviewed	Authorised	Issue Date
Description						
Status	Revision	Drawn	Checked	Reviewed	Authorised	Issue Date
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Status	Revision	Drawn	Checked	Reviewed	Authorised	Issue Date
A1	C01	AC	SS	CDC	BM	17/10/23
Drawing Suitability						Status
APPROVED - PUBLISHED						A1

Project Title			
M5 Junction 10 Improvements Scheme			
Drawing Title			
BIODIVERSITY SITES AND FEATURES PLAN			
SHEET 8 OF 16			
Drawing Number			
GCCM5J10	ATK	EBD	
ZZ	DR	LS	000009
Original Size: A1	Scale: AS SHOWN	Project Ref. No.: 5197035	Sheet: 8 of 16 Rev: C01



FOR CONTINUATION REFER TO SHEET 8

TOWARDS M5
JUNCTION 10

M5 MAINLINE

OLD GLOUCESTER ROAD

BODDINGTON CP
STAVERTON CP

Ponds

Mast

Track

M5

B 4634

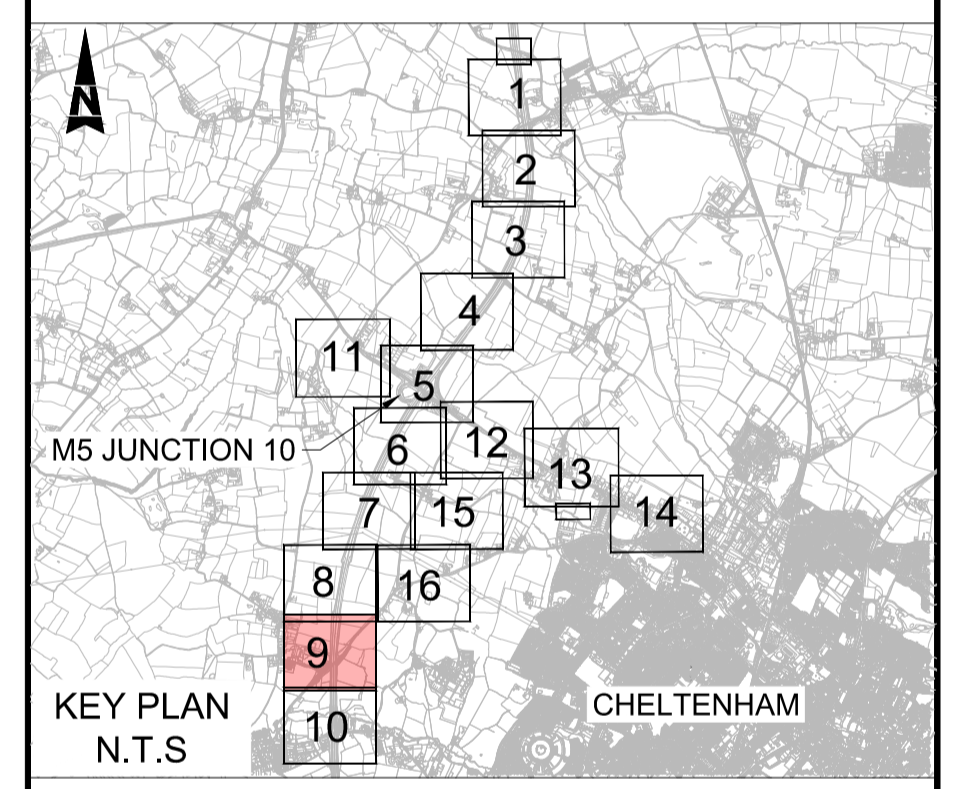
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TOWARDS M5
JUNCTION 11

FOR CONTINUATION REFER TO SHEET 10

- NOTES:**
1. ALL DIMENSIONS ARE IN METRES UNLESS OTHERWISE STATED.
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- KEY**
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Description						
Status	Revision	Drawn	Checked	Reviewed	Authorised	Issue Date
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Status	Revision	Drawn	Checked	Reviewed	Authorised	Issue Date
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APPROVED - PUBLISHED						A1

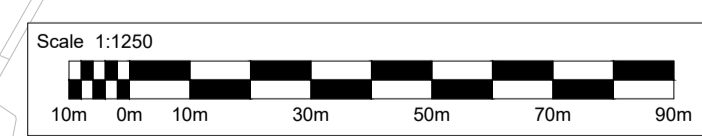
Project Title
M5 Junction 10 Improvements Scheme

Drawing Title
BIODIVERSITY SITES AND FEATURES PLAN

SHEET 9 OF 16

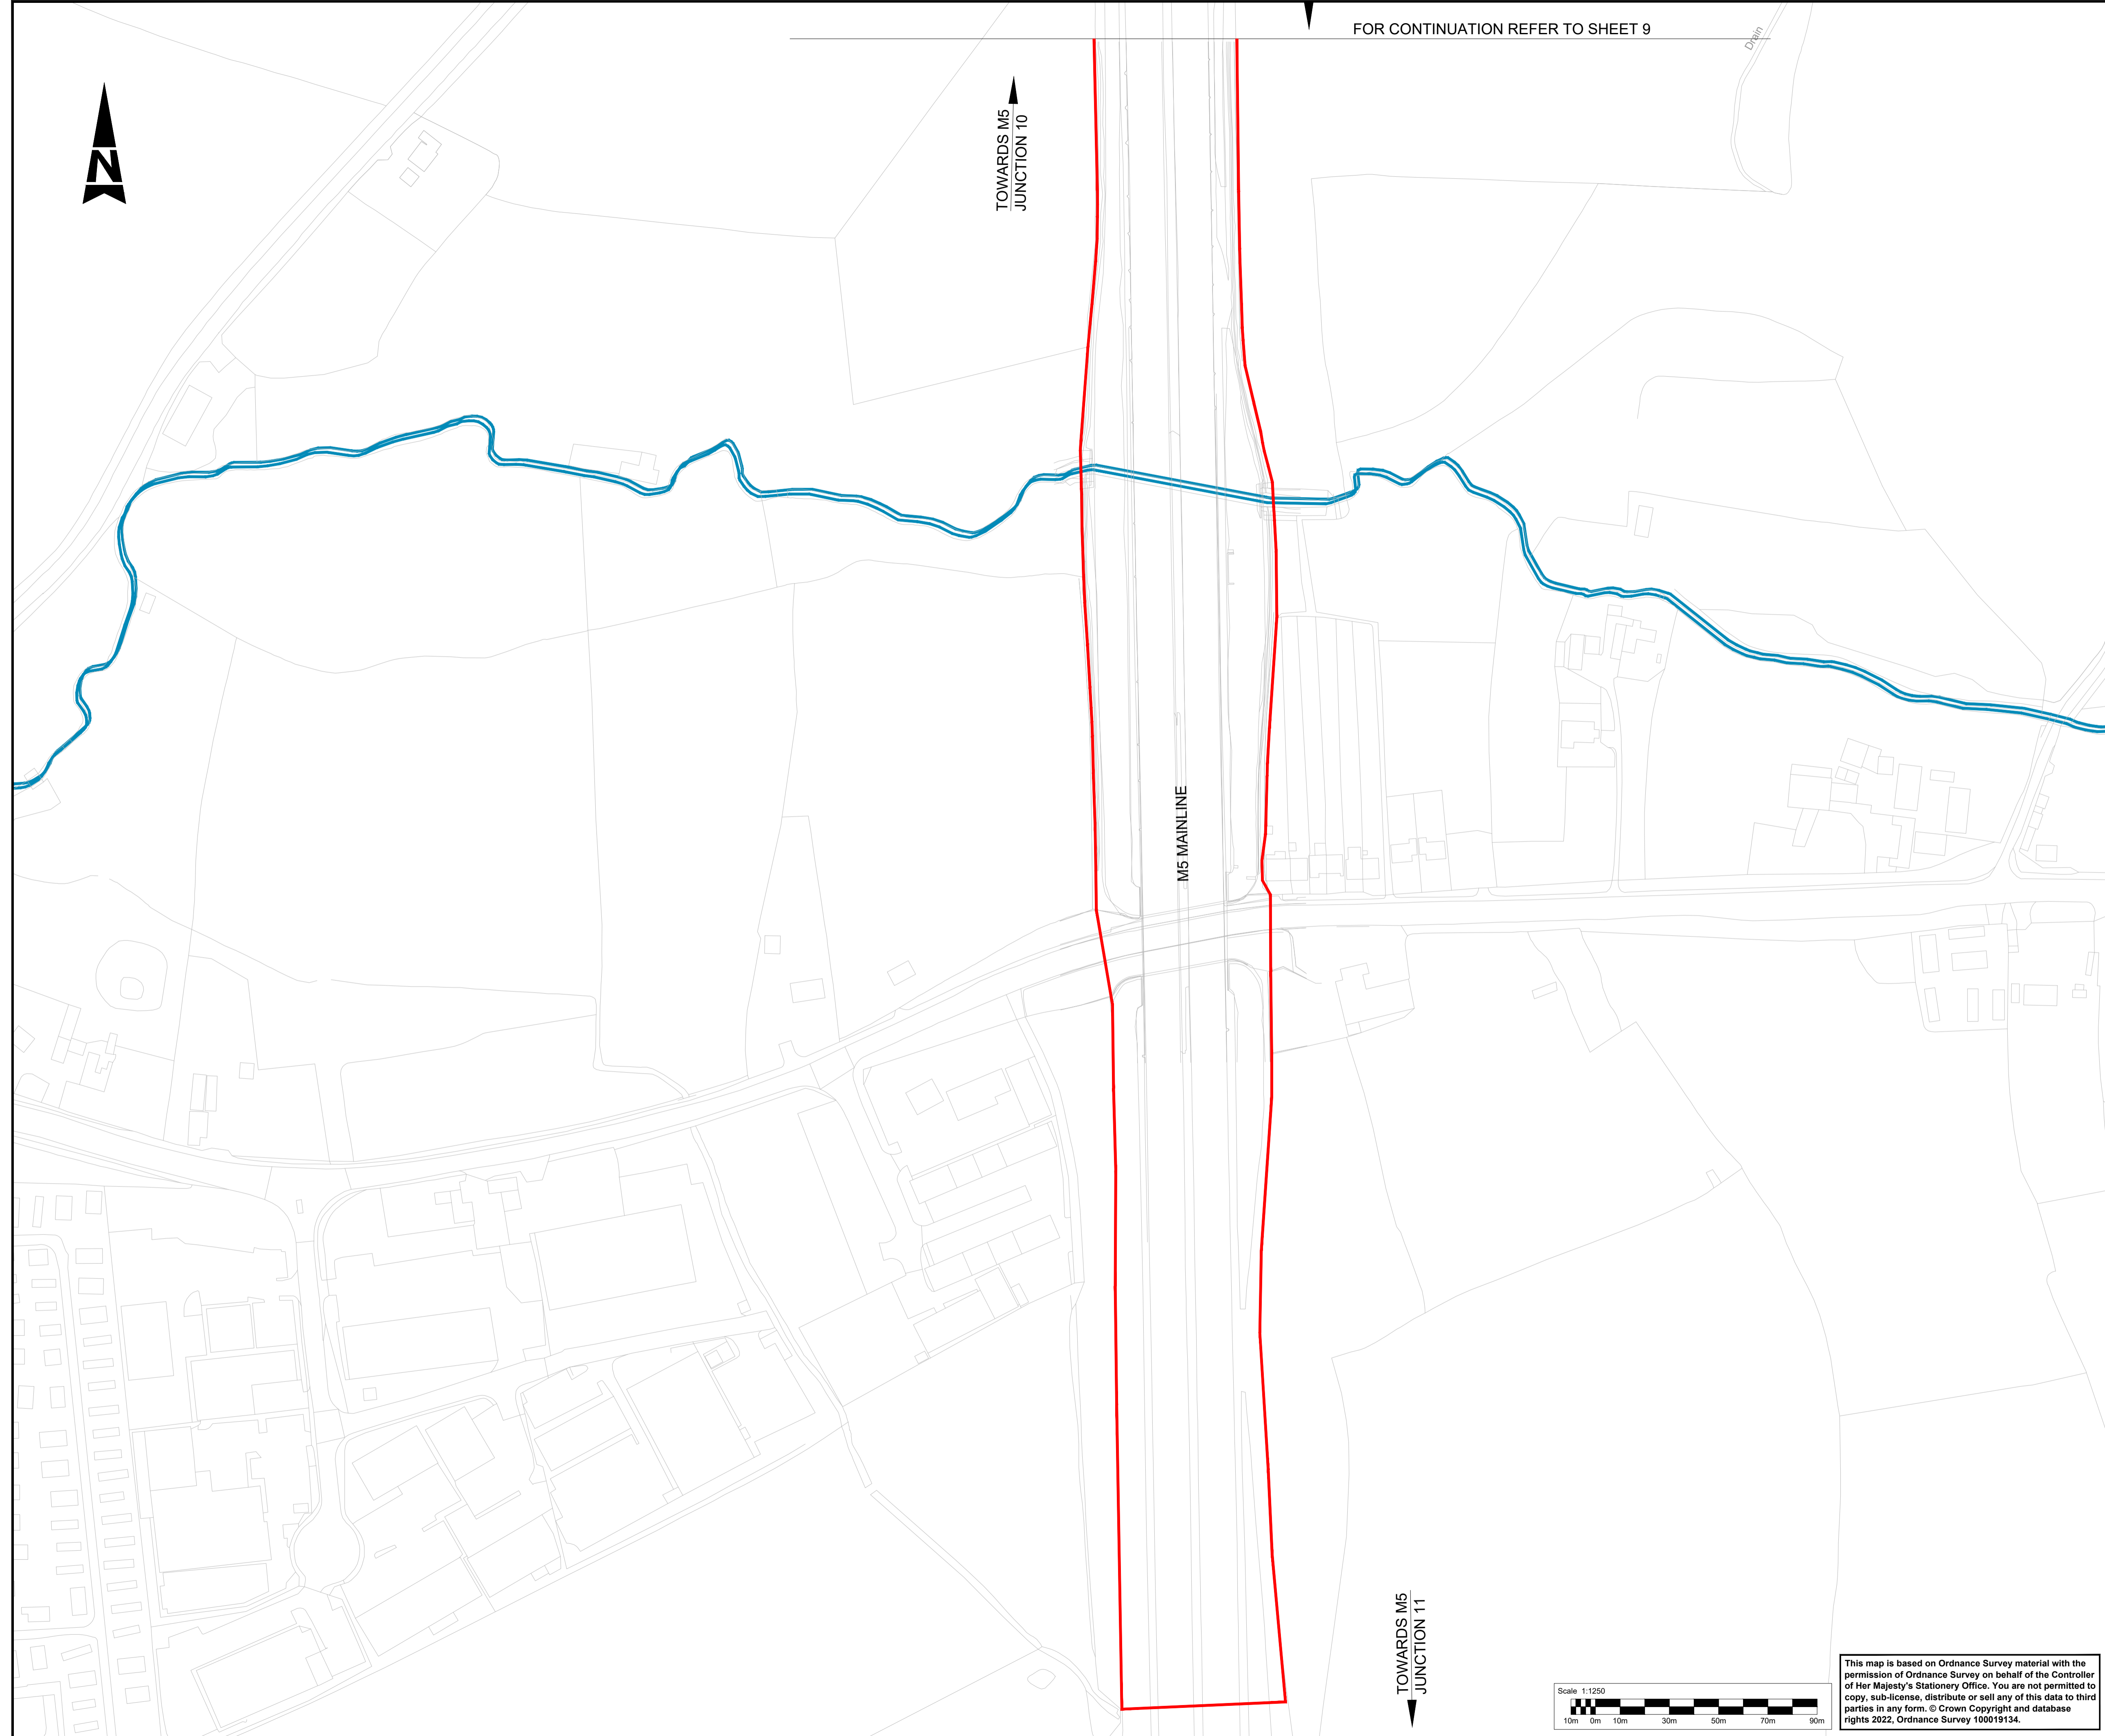
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**GCCM5J10 ATK EBD
ZZ DR LS 000010**

Original Size: **A1** Scale: **AS SHOWN** Project Ref. No.: **5197035** Sheet: **9 of 16** Rev: **C01**



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


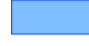
FOR CONTINUATION REFER TO SHEET 9

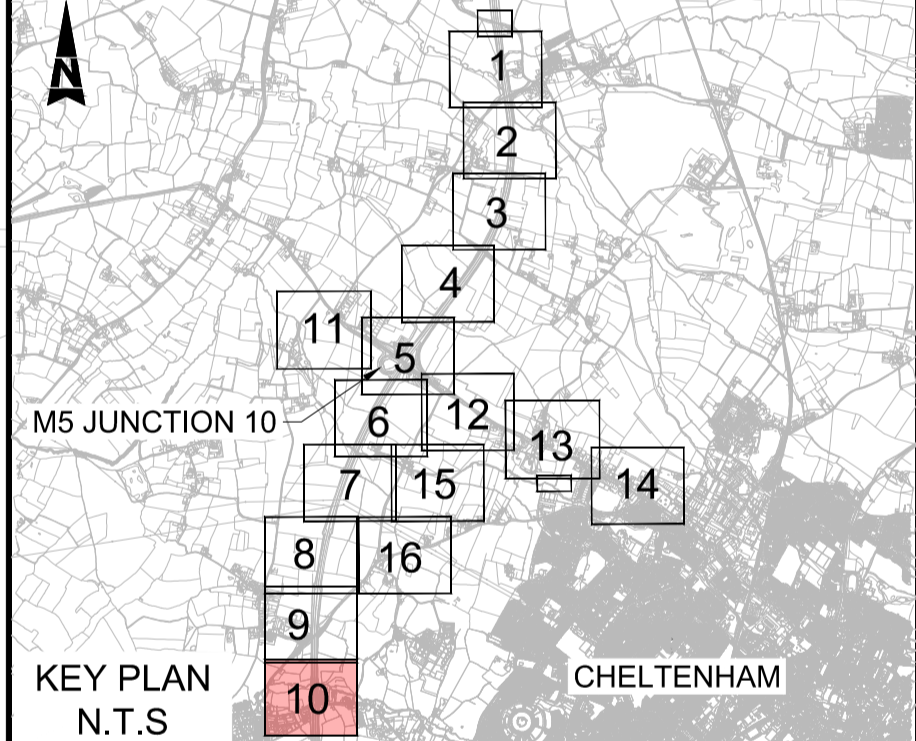


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Status	Revision	Drawn	Checked	Reviewed	Authorised	Issue Date
A1	C01	AC	SS	CDC	BM	17/10/23
Drawing Suitability					Status	
APPROVED - PUBLISHED					A1	
Project Title						
M5 Junction 10 Improvements Scheme						
Drawing Title						
BIODIVERSITY SITES AND FEATURES PLAN						
SHEET 10 OF 16						
Drawing Number						
GCCM5J10	ATK	EBD		ZZ DR LS 000011		
Original Size: A1 Scale: AS SHOWN Project Ref. No.: 5197035 Sheet: 10 of 16 Rev: C01						

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